

KANAWHA ZONING DRAWINGS

SITE FA # 14878905 SITE ID # 2544 3557 BERRYVILLE PIKE CHARLES TOWN, WV 25414

SITE INFORMATION

SCOPE OF WORK:

- PROPOSED 50'X50' COMPOUND
- INSTALL STEEL WIC
- INSTALL 12'x16' CONCRETE PAD
- INSTALL 30KW DIESEL GENERATOR INSTALL HEAVY DUTY ANTENNA PLATFORM
- INSTALL 6 ANTENNAS
- INSTALL 12 RRH's
- 8. INSTALL COMPONENTS SUPPORTING ANTENNAS' OPERATION AS DESCRIBED PER
- DRAWINGS
- 9. PROPOSED 12' GRAVEL ACCESS ROAD

SITE NAME: KANAWHA RELO RIPPON

SITE FA #: 14878905

SITE ID #:

3557 BERRYVILLE PIKE SITE ADDRESS:

CHARLES TOWN, WV 25414

JEFFERSON COUNTY JURISDICTION:

INDUSTRIAL/COMMERCIAL ZONING:

AT&T MOBILITY TOWER OWNER:

PROPERTY OWNER: 220 ARBOR COURT

WINCHESTER, VA 22602

340 RAINBOW LLC.

LATITUDE: (39.238308) N 39° 14' 17.91" (NAD-83)

(-77.900253) W 77° 54' 00.91" (NAD-83) LONGITUDE:

507' ± AMSL ELEVATION:

USE GROUP:

ΙΙΒ CONST. TYPE:

THE CONTRACTOR MUST VERIFY ALL FIELD MEASUREMENTS AND CONDITIONS PRIOR TO BID AND TO COMMENCEMENT OF CONSTRUCTION.

VICINITY MAP 15/2

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PROJECT TEAM	PI	RO.	JΕ	CT	TE	AN	ı
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APPLICANT: AT&T MOBILITY

7150 STANDARD DR.

HANOVER, MD 21076

KCI TECHNOLOGIES INC. ARCHITECT/ENGINEER: 11830 WEST MARKET PLACE, SUITE F

FULTON, MD 20759

NICHOLAS BARRICK (410) 792-8086

PROJECT MANAGEMENT: SMARTLINK LLC

1362 MELLON ROAD, SUITE 140

HANOVER, MD 21076 PHONE: (410) 582-8043

CODE COMPLIANCE

- * ALL WORK SHALL BE PERFORMED AND MATERIALS INSTALLED IN ACCORDANCE WITH THE FOLLOWING CODES AS ADOPTED BY THE LOCAL GOVERNING AUTHORITIES. NOTHING IN THESE PLANS IS TO BE CONSTRUED TO PERMIT WORK NOT CONFORMING TO THESE
 - 2015 INTERNATIONAL BUILDING CODE
 - 2015 INTERNATIONAL FUEL GAS CODE (IFGC)
 2011 INTERNATIONAL ELECTRICAL CODE

_	2009	INTERNATIONAL	ENERGY	CONSERVATION	CODE

	APPROVAL BLO	CK		
		APPROVED	APPROVED AS NOTED	REVISE & RESUBMIT
OWNER REPRESENTATIVE	DATE			
SITE AQUISITION	DATE			
CONSTRUCTION MANAGER	DATE			
ZONING	DATE			
RF ENGINEER	DATE			

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DRA	AWN BY:	JW
CHE	CKED BY:	JM
APF	PROVED B'	Y: GT
NO.	DATE	DESCRIPTION
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С	06/13/19	REVISED PER COMMENTS
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Н	05/24/21	POWER ROUTE CHANGE
1	06/02/21	DIMENSION ADDED
J	06/22/21	REVISED PER COMMENTS
0	04/15/22	ISSUED FOR ZONING



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NICHOLAS A. BARRICK, PE WV LICENSE NO.: 20290




HANOVER, MD 21076

KANAWHA

3557 BERRYVILLE PIKE CHARLES TOWN, WV 25414

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SHEET TI	
KCI JOB I	NUMBER: 011802184.ATT04
DATE:	04/15/22
SCALE:	AS NOTED

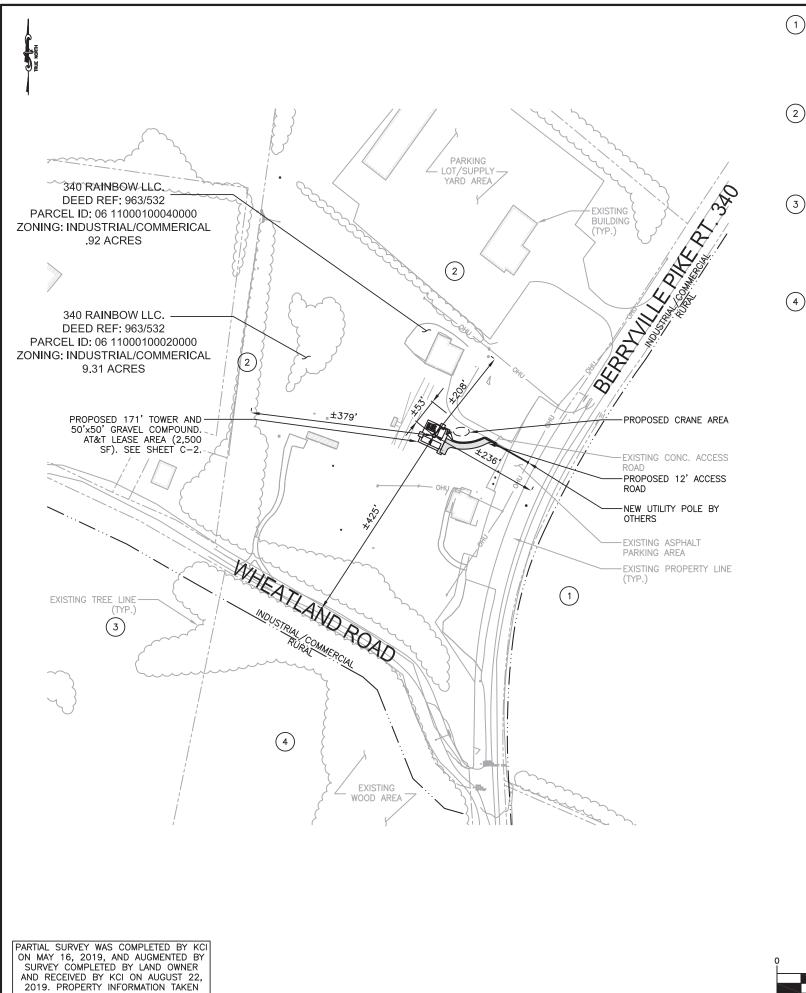

FROM JEFFERSON COUNTY GIS WEBSITE.

STOLIPHER, DOUGLAS L. 1599 ROPER NORTH FORK ROAD CHARLES TOWN, WV 254141308 PARCEL ID: 06 11000200000000 LIBER/FOLIO: 1026/337 DISTANCE FROM CLOSEST PROPERTY LINE TO MONOPOLE ±261'

W A CHESTER LLC. 0 P.O. BOX 3841 CHICAGO, IL 60654 PARCEL ID: 06 11000100030000 LIBER/FOLIO: 1062/369 DISTANCE FROM CLOSEST PROPERTY LINE TO MONOPOLE ±193 11.26 AC

CARLISLE W O JR ET AL 0 P.O. BOX 103 RANSON, WV 25438 PARCEL ID: 06 12001600020000 LIBER/FOLIO: 935/563 DISTANCE FROM CLOSEST PROPERTY LINE TO MONOPOLE ±506' 7.24 AC

HARRISON, IAN W. & VIRGINIA N. 154 JENKINS HILL ROAD CHARLES TOWN, WV 25414 PARCEL ID: 06 12001600040000 LIBER/FOLIO: 944/24 DISTANCE FROM CLOSEST PROPERTY LINE TO MONOPOLE ±459' 18.85 AC

SITE NOTES

1. APPLICANT/OWNER: AT&T MOBILITY CONTACT: JACKSON CLARK 7150 STANDARD DRIVE HANOVER, MD 21076

2. SITE DATA:

PARCEL # .: 06 11000100020000 WATER DESIGNATION: SEWER DESIGNATION: **PUBLIC** ELECTION DISTRICT: 9.31 AC. SITE AREA:

3557 BERRYVILLE PIKE SITE ADDRESS: CHARLES TOWN, WV 25414

3. EXISTING USE: MECHANICS SHOP

PROPOSED USE: MECHANICS SHOP/TELECOMMUNICATION FACILITY

ZONING OF SITE IS INDUSTRIAL/COMMERCIAL

LIMIT OF DISTURBANCE = 6,319 sq.ft or 0.15 Ac. EXISTING IMPERVIOUS AREA = 41,311 sq.ft

PROPOSED IMPERVIOUS AREA = 2,645 sq.FT NEAREST HISTORICAL STRUCTURE IS BEULAH CHURCH WHICH IS ±450' SOUTHWEST OF PROPOSED TOWER.

 NO COMMERCIAL SIGNAGE IS PROPOSED.
 TOWER SHALL NOT BE LIGHTED OR REQUIRED BY THE FCC AND FAA. MARKED UNLESS SO

11. TOWER TO BE FLAT GREY OR GALVANIZED FINISH, UNLESS OTHERWISE DETERMINED BY THE PLANNING COMMISSION.


12. ANY FACILITY OR SUPPORT STRUCTURE IS NOT OPERATED FOR A PERIOD OF TWELVE (12) CONSECUTIVE MONTHS MAY BE REFERRED TO THE PROPERTY SAFETY ENFORCEMENT AGENCY BOARD FOR A DETERIORATION OF THE STRUCTURAL SOUNDNESS OF THE FACILITY OR STRUCTURE.

13. NOTIFY WEST VIRGINIA 811 48 HOURS PRIOR TO DOING ANY EXCAVATION IN THIS AREA. THE LOCATIONS OF EXISTING UNDERGROUND UTILITIES ARE SHOWN IN AN APPROXIMATE WAY ONLY AND HAVE NOT BEEN INDEPENDENTLY VERIFIED BY THE OWNER OR ITS REPRESENTATIVE. THE CONTRACTOR SHALL DETERMINE THE EXACT LOCATION OF ALL EXISTING UTILITIES BEFORE COMMENCING WORK, AND AGREES TO BE FULLY RESPONSIBLE FOR ANY AND ALL DAMAGES WHICH MIGHT BE OCCASIONED BY THE CONTRACTOR'S FAILURE TO EXACTLY LOCATED AND PRESERVE ANY AND ALL UNDERGROUND UTILITIES.

DRAWN BY: CHECKED BY: APPROVED BY REVISED PER COMMENTS COMPOUND RELOCATION 10/28/1 REVISED PER COMMENTS REVISED TOWER LOCATION REVISED GRAVEL ACCESS POWER ROLLTE CHANGE DIMENSION ADDED REVISED PER COMMENTS SUFD FOR ZONING



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ENGINEER: NICHOLAS A. BARRICK, PE WV LICENSE NO.: 20290

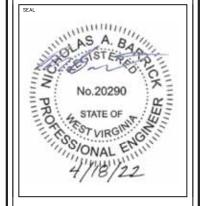

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PROPERTY & **ZONING PLAN**

LEGEND

PROPERTY LINE EX. CONTOUR EX. EDGE OF ROAD EX. UTILITY POLE EX. BUILDING EX. FEATURES

INDUSTIRAL/COMMERCIAL EX. ZONING LINE

PROP. FENCE PROP. EQUIPMENT

EX. TREES


PROP. MONOPOLE PROP. TELECOM LINE

PROP. ELECTRIC LINE

PROPERTY & ZONING PLAN

SCALE: 1"=200' (1"=100') ON 22"x34" SHEET)


GRAPHIC SCALE

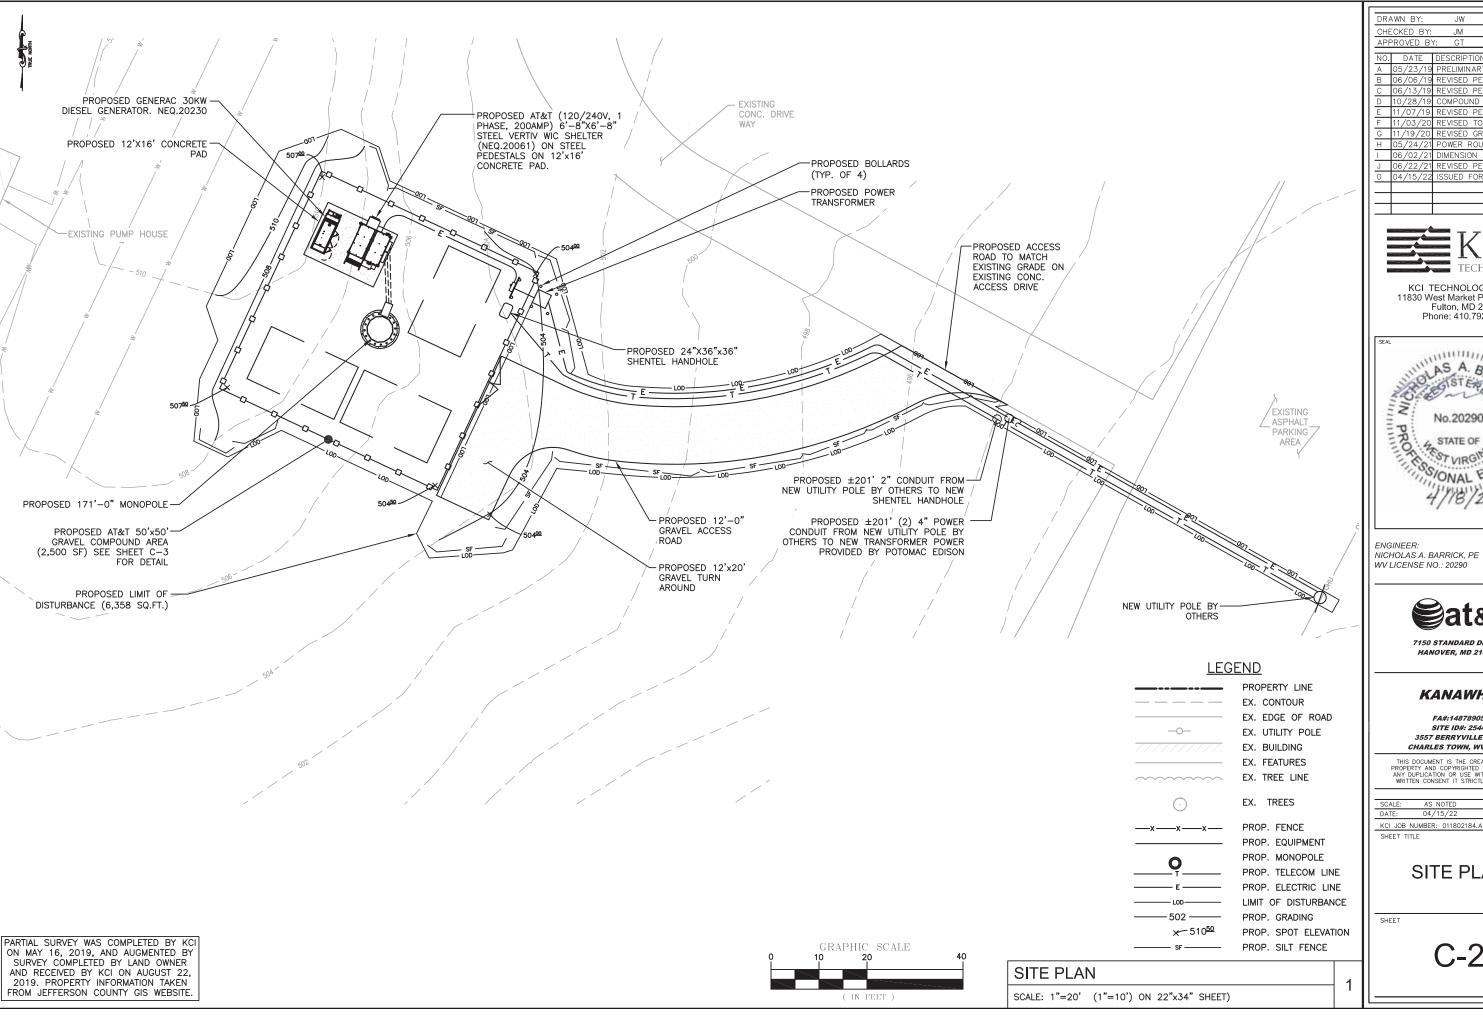

ı	DRA	AWN BY:	JW
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ı		PROVED BY	
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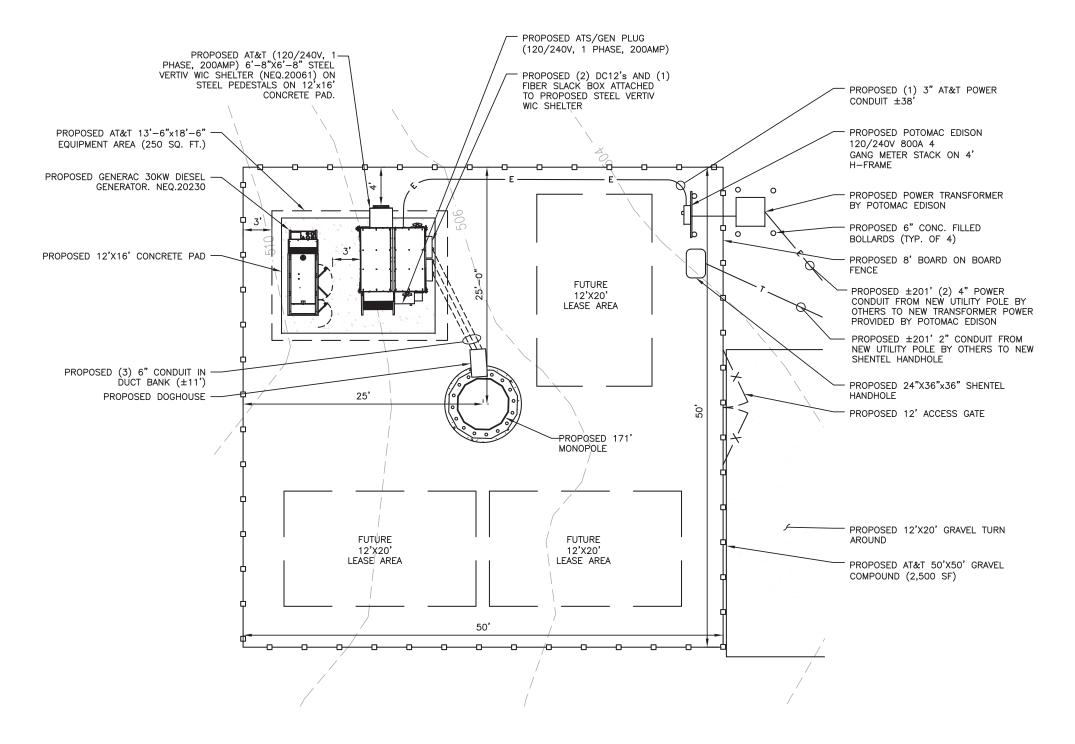
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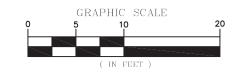
SCALE:	AS NOTED
DATE:	04/15/22

KCI JOB NUMBER: 011802184.ATT04

SITE PLAN

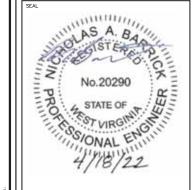





COMPOUND PLAN

SCALE: 1"=10' (1"=5') ON 22"x34" SHEET)

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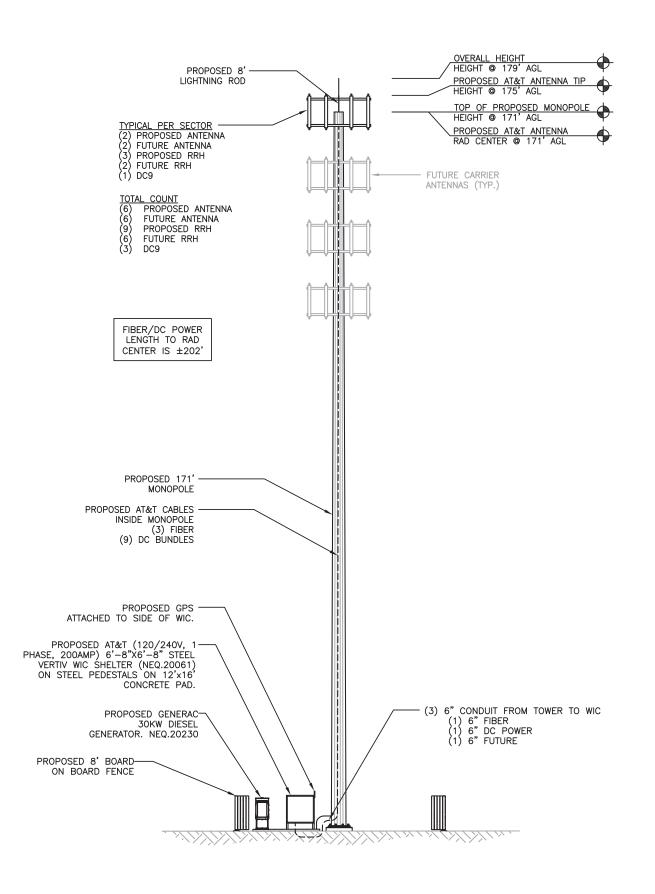
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Ш	SCALE: AS NOTED	
Ш	DATE: 04/15/22	
Ш	KCI JOB NUMBER: 011802184.ATT04	
Ш	SHEET TITLE	

COMPOUND PLAN

SHEET


C-3



DRAWN BY: CHECKED BY: APPROVED BY: NO. DATE DESCRIPTION A 05/23/19 PRELIMINARY DRAWINGS B 06/06/19 REVISED PER COMMENTS C 06/13/19 REVISED PER COMMENTS
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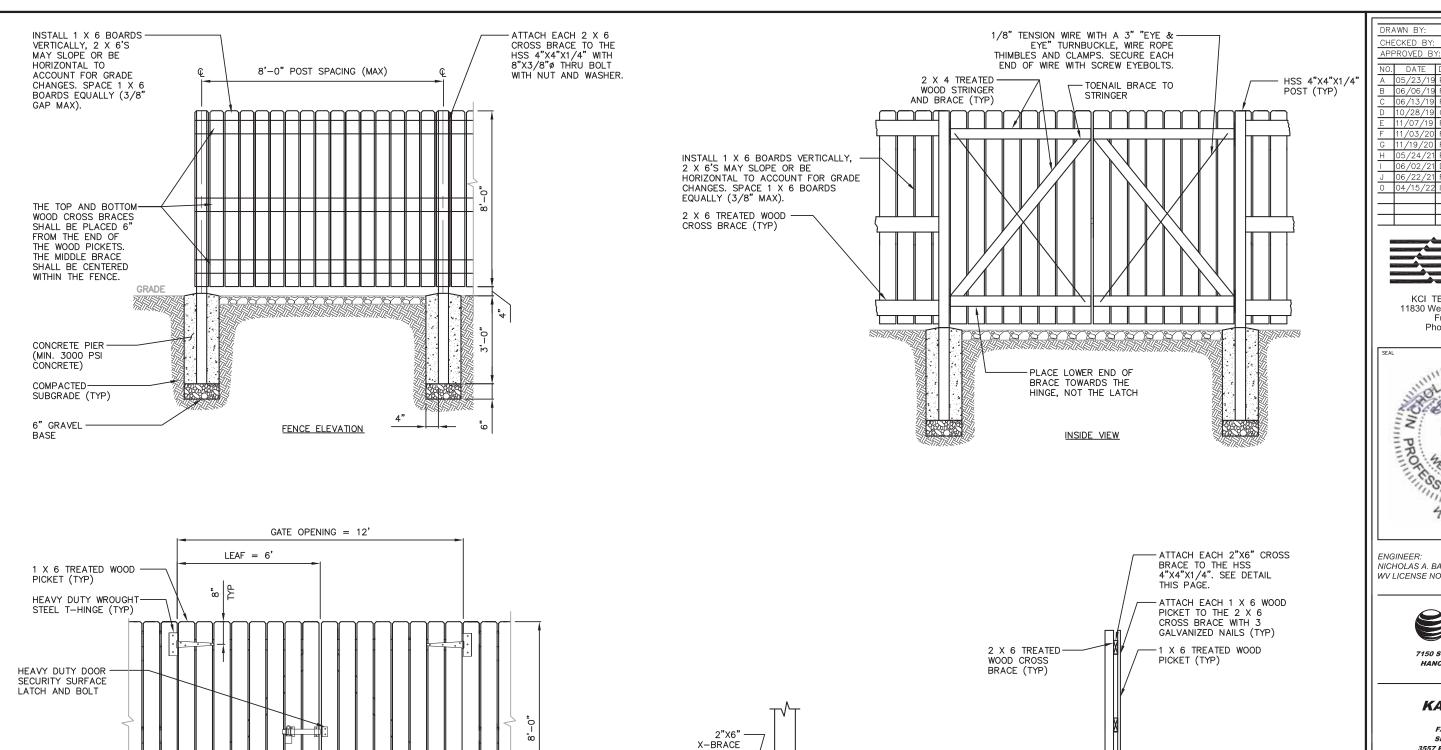
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TOWER ELEVATION

TOWER ELEVATION

SCALE: N.T.S

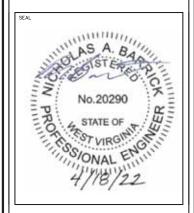1



FENCE SECTION

12"Ø CONCRETE PIER-(MIN. 3000 PSI CONCRETE)

OUTSIDE VIEW

COMPACTED——SUBGRADE (TYP)

6" GRAVEL BASE HSS 4"X4"X1/4"

STEEL PÓST

√°¦1 1/2"

X-BRACE TO POST CONNECTION

FOR 8"X3/8"

AND WASHER

THRU BOLT

HSS 4"X4"X1/4"-


OF PIER FOR DRAINAGE


1" CROWN AT TOP


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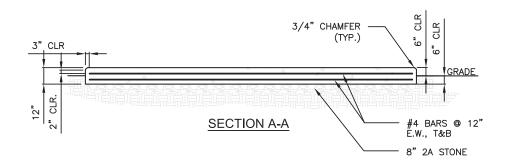
FENCING DETAIL

SCALE: N.T.S.



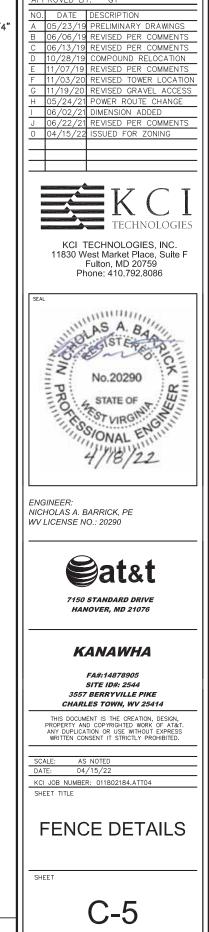

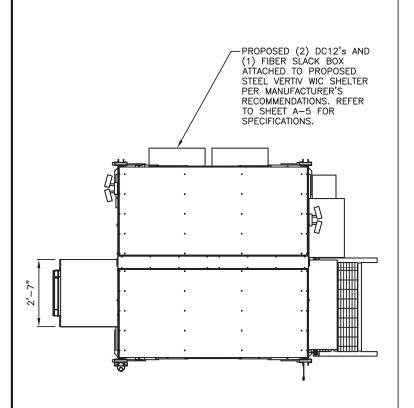

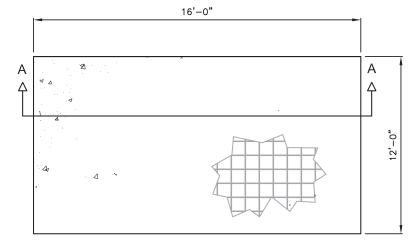

WIC SHELTER SLAB NOTES:


- VERIFY DIMENSIONS WITH WIC MANUFACTURER.
 REMOVE ALL LOOSE INORGANIC OR UNSUITABLE SOIL TO UNDISTURBED BEARING STRATA W/ ALLOWABLE SOIL BEARING PRESSURE OF 2000 PSF.
- CONCRETE STRENGTH SHALL BE 4000 PSI, MIN.
- SLAB SHALL BE LEVEL ±1/4"


 THE "UNDISTURBED SOIL" BASE SHALL BE COMPACTED TO AT LEAST 95% MODIFIED PROCTOR MAXIMUM DENSITY PER ASTM D 1557 METHOD C.

WIC SHELTER FOUNDATION DETAIL

SCALE: N.T.S.

SCALE: N.T.S.

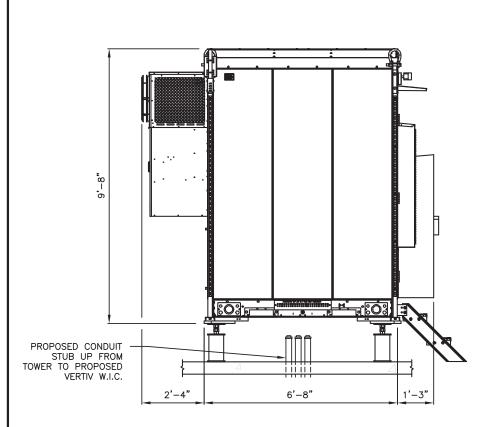


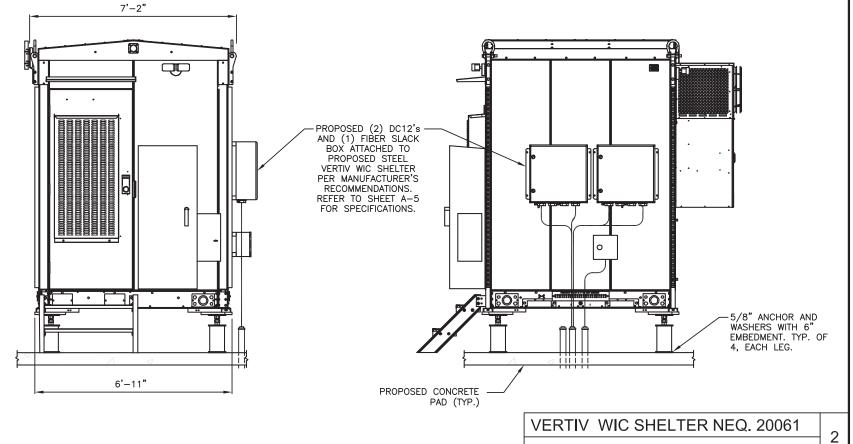

DRAWN BY: CHECKED BY: APPROVED BY: C 06/13/19 D 10/28/19 REVISED PER COMMENTS COMPOUND RELOCATION REVISED PER COMMENTS REVISED TOWER LOCATION G 11/19/2 REVISED GRAVEL ACCESS POWER ROLLTE CHANGE DIMENSION ADDED REVISED PER COMMENTS



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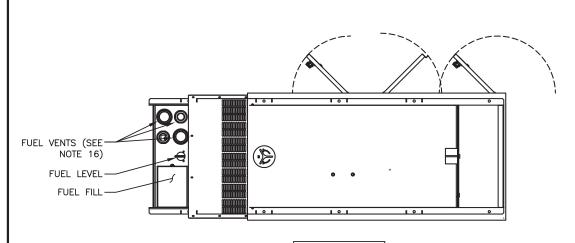
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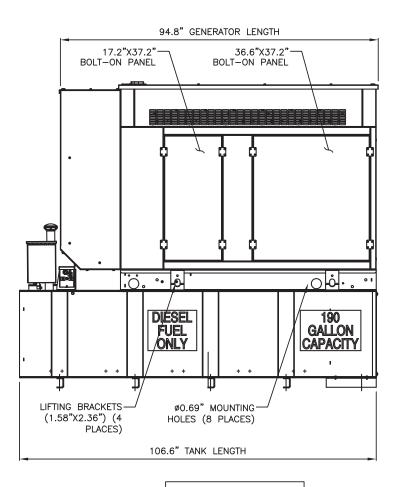
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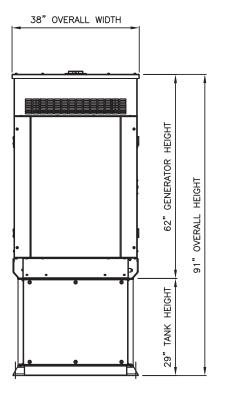
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WIC **SPECIFICATIONS**

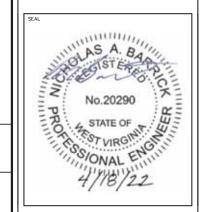

TOP VIEW





LEFT SIDE VIEW

REAR VIEW


NOTES:

- CONTROL PANEL INCLUDES BATTERY CHARGER WITH THREE PRONG CORD.
- 2. 1500W 120VAC ENGINE BLOCK HEATER WITH THREE PRONG CORD.
- 3. 12 VOLT NEGATIVE GROUND SYSTEM.
- 4. GENERATOR MUST BE GROUNDED.
- 5. CENTER OF GRAVITY & WEIGHT MAY SHIFT SLIGHTLY DUE TO UNIT
- STUB-UPS: BASE TANK REQUIRES ALL STUB-UPS TO BE IN THE REAR TANK STUB-UP AREA.
- 7. HIGH VOLTAGE STUB-UP AREA INCLUDES THE AC LOAD LEAD CONNECTION TO THE MAIN LINE CIRCUIT BREAKER, THE NEUTRAL CONNECTION, AND AUXILIARY 120/240V CONNECTION.
- 8. CONNECTION POINTS FOR CONTRÓL WIRES. BOTTOM OF LOW VOLTAGE CUSTOMER CONNECTION BOX HAS KNOCKOUTS FOR 1/2" AND 3/4" CONDUIT FITTINGS.
- 9. MUST ALLOW FREE FLOW OF DISCHARGE AIR AND EXHAUST. SEE SPEC SHEET FOR MINIMUM AIR FLOW AND MAXIMUM RESTRICTION REOLIREMENTS.
- 10. MUST ALLOW FREE FLOW OF INTAKE AIR. SEE SPEC SHEET FOR MINIMUM AIR FLOW AND MAXIMUM RESTRICTION REQUIREMENTS.
- 11. GENERATOR MUST BE INSTALLED SUCH THAT FRESH COOLING AIR IS AVAILABLE AND THAT DISCHARGE AIR FROM THE RADIATOR IS NOT RECIRCULATED.
- 12. IT IS THE RESPONSIBILITY OF THE INSTALLATION TECHNICIAN TO ENSURE THAT THE GENERATOR INSTALLATION COMPLIES WITH ALL APPLICABLE CODES, STANDARDS, AND REGULATIONS.
- APPLICABLE CODES, STANDARDS, AND REGULATIONS.

 13. 190 GALLON USEABLE CAPACITY BASETANK IS INCLUDED WITH
- GENERATOR.

 14. UNIT IS SHIPPED WITH FUEL SUPPLY AND RETURN LINES
 DISCONNECTED AND PLUGGED BETWEEN ENGINE AND FUEL TANK. THIS
 HAS BEEN DONE TO FACILITATE PRESSURE TESTING OF THE TANK IN
 THE FIELD. FOR INFORMATION REGARDING CONNECTING THE FUEL
 SUPPLY AND RETURN LINES PRIOR TO START UP, SEE THE FUEL TANK
 FIELD TESTING PROCEDURE (0E5082) SUPPLIED IN THE TANK LOOSE
 VENTS KIT, WHICH IS SHIPPED WITH THIS GENERATOR.
- 15. SEE DRAWING 0C3850 FOR DISCHARGE DUCT REMOVAL. REMOVAL OF DUCT WILL PROVIDE ACCESS TO MUFFLER FOR SERVICING.
- 16. ADDITIONAL 2" FEMALE NPT PORTS PLUGGED OR EQUIPPED WITH TOP—MOUNT SWITCHES DEPENDING ON UNIT OPTIONS.

WEIGHT DATA: (INCLUDES EMPTY FUEL TANK)
GENERATOR: 1358 KG (2995 LBS)
GENERATOR WITH WOODEN SHIPPING SKID: 1424 KG (3139 LBS)

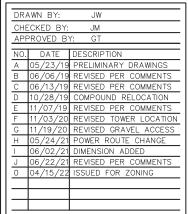



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GENERATOR DETAILS


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C-7

GENERAC - DIESEL 30kW - NEQ: 20230





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SECTOR CONFIGURATION

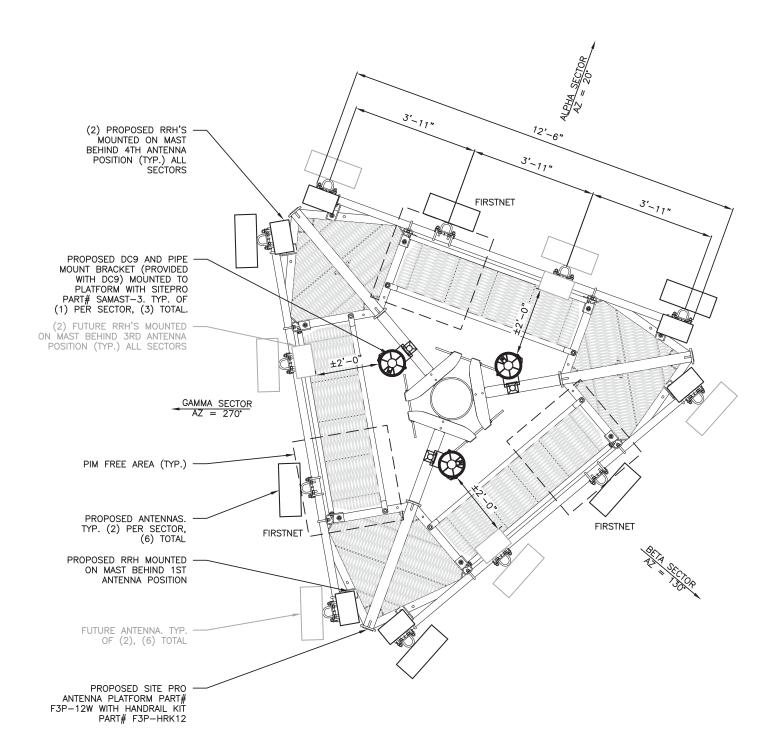1

A-1

PROPOSED ANTENNA CONFIGURATION

SCALE: 1"=3' (1"=1.5') ON 22"x34" SHEET)

	ANTENNA SCHEDULE													
SECTOR POSITION	STATUS	ANTENNA MANUFACTURE	ANTENNA MODEL	ANTENNA DIMENSIONS	RAD CENTER	AZIMUTH	TMA/RRU QUANTITY & MODEL	ANTENNA E-TILT	ANTENNA M-TILT	FIBER/POWER FEEDERS	TRUNK LENGTH			
A-1	FUTURE	-	_	_	-	-	_	-	_					
A-2	PROPOSED	COMMSCOPE	NNHH-65C-R4	96x19.6x8.2	171' AGL	20°	(1) B12/14 DUAL BAND RRH 320W (AHLBA)	_	0	(1) 24 PAIR FIBER-OPTIC				
A-2	PROPOSED	COMMSCOPE	NNHH-03C-R4			1/1 AGL	1/1 AGL	20	(1) AIRSCALE DUAL RRH4T4R B25/66 320W (AHFIB)	_	U	TRUNK CABLE (PER SECTOR) (3) 9-C DC TRUNK CABLES	±202'	
A-3	PROPOSED	COMMSCOPE	NNHH-65C-R4	96x19.6x8.2	171' AGL	20°	(1) AIRSCALE RRH 4T4R B5 160W (AHCA)	-	0	(PER SECTOR)				
A-4	FUTURE	_	_	_	_	_	_	_	_					
B-1	FUTURE	-	_	-	-	_	-	_	_					
			NNHH_65C_P4 96x19.6x8.2		06:10 6:18 2				(1) B12/14 DUAL BAND RRH 320W (AHLBA)			(1) 24 PAIR FIBER-OPTIC		
B-2	PROPOSED	COMMSCOPE	NNHH-65C-R4	30x19.0x0.2	171' AGL	130°	(1) AIRSCALE DUAL RRH4T4R B25/66 320W (AHFIB)	_	0	TRUNK CABLE (PER SECTOR) (3) 9-C DC TRUNK CABLES	±202'			
B-3	PROPOSED	COMMSCOPE	NNHH-65C-R4	96x19.6x8.2	171' AGL	130°	(1) AIRSCALE RRH 4T4R B5 160W (AHCA)	-	0	(PER SECTOR)				
B-4	FUTURE	_	_	_	_	_	_	_	_					
G-1	FUTURE	-	-	_	-	_	_	-	-					
				96x19.6x8.2	NNHH-65C-R4 96x19.6x8.2	NNHH-65C-R4 96x19.6x8.2 171' AGL			(1) B12/14 DUAL BAND RRH 320W (AHLBA)			(1) 24 PAIR FIBER-OPTIC		
G-2	PROPOSED	COMMSCOPE	NNHH-65C-R4				-65C-R4 96x19.6x8.2 171	171' AGL	171' AGL	171' AGL	96X19.6X8.2 171' AGL	171' AGL 270°	(1) AIRSCALE DUAL RRH4T4R B25/66 320W (AHFIB)	-
G-3	PROPOSED	COMMSCOPE	NNHH-65C-R4	96x19.6x8.2	171' AGL	270°	(1) AIRSCALE RRH 4T4R B5 160W (AHCA)	_	0	(PER SECTOR)				
G-4	FUTURE	_	-	_	-	-	_	-	_					


CABLE SYTSTEM & RF SYSTEM DESIGN PLAN NOTES:

- 1. SECTOR ORIIENTATION/AZIMUTH WILL VARY FROM REGION TO REGION AND IS SITE SPECIFIC. REFER TO SEPARATE RF REFPORT FOR EACH SITE TO DETERMINE THE ANTENNA LOCATION AND FUNCTION OF EACH TOWER SECTOR FACE.
- THE STANDARD IS BASED ON EIGHT COLORED TAPES RED, BLUE, GREEN, YELLOW, BROWN, ORANGE, WHITE, AND SLATE (GREY). THESE TAPES SHOULD BE READILY AVAILABLE TO THE ELECTRICIAN OR CONTRACTOR ON SITE.
- 3. USING COLOR BANDS ON THE CABLES, MARK ALL RF CABLE BY SECTOR AND CABLE NUMBER AS SHOWN ON "CABLE MARKING COLOR CONVENTION TABLE".
- 4. COLOR CODE TAPE SHALL BE 3" WIDE AT TOP AND MIDDLE OF TOWER AND 2" WIDE AT THE BOTTOM. ALL JUMPERS SHALL BE INCLUDED.
- 5. ALL COLOR CODE TAPE SHALL BE 3M-35 AND SHALL BE INSTALLED USING A MINIMUM OF (3) WRAPS OF TAPE AND SHALL BE NEATLY TRIMMED AND SMOOTHED OUT SO AS TO AVOID UNRAVELING.
- 6. ALL COLOR BANDS INSTALLED AT OR NEAR THE GROUND SHALL BE A MINIMUM OF
- 7. ALL COLOR CODES SHALL BE INSTALLED SO AS TO ALIGN NEATLY WITH ONE ANOTHER FROM SIDE-TO-SIDE.

CABLE IDENTIFICATION NOTES:

- 1. SUBCONTRACTOR SHALL COORDINATE COLOR CODING WITH THE MASTER COLOR CODE
- 2. SUB CONTRACTOR SHALL INSTALL A BRASS IDENTIFICATION TAG (1-1/2" IN DIAMETER WITH 1/4" STAMPED LETTERS AND NUMBERS) ONE AT THE ANTENNA PORT CONNECTION NEAR THE END OF THE JUMPER AND ONE ON EACH END OF THE JUMPER SERVING THE RADIO EQUIPMENT. EACH TAG WILL BE STAMPED WITH "ATT" AND THE ANTENNA PORT IDENTIFICATION NUMBER EXAMPLE BELOW. TAGS SHALL BE ATTACHED WITH CORROSION PROOF UV RESISTANT MRE OR CABLE-TY.

RF DESIGN NOTE: RF DESIGN NOTE:
THIS ANTENNA AND COAX CABLE SCHEDULE HAS BEEN
CREATED USING THE FOLLOWING RFDS DATED 05/06/19, REVISION V2019_1.0 ALL ANTENNA DESIGN, ZONING, STRUCTURAL ANALYSIS PERMITS AND COMPLIANCE SUBMISSIONS ARE COORDINATED WITH THE AFOREMENTIONED DOCUMENT.

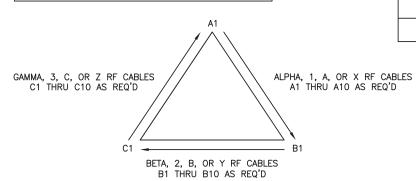


PROPOSED ANTENNAS	TOTAL
(2) PER SECTOR	(6)
FUTURE ANTENNAS	
(2) PER SECTOR	(6)

PROPOSED RRH (PER SECTOR)	TOTAL	
(1) B12/14 DUAL BAND RRH 320W (AHLBA)	(3)	
(1) AIRSCALE DUAL RRH 4T4R B25/66 320W AHFIB	(3)	
(1) AIRSCALE RRH 4T4R B5 160W ACHA	(3)	
	·	
FUTURE RRH (PER SECTOR)	TOTAL	
(1) FUTURE RRH	(3)	

DR/	DRAWN BY: JW			
CHE	CHECKED BY: JM			
APF	PROVED BY	Y: GT		
NO.	DATE	DESCRIPTION		
A	05/23/19	PRELIMINARY DRAWINGS		
В	06/06/19	REVISED PER COMMENTS		
С	06/13/19	REVISED PER COMMENTS		
D	10/28/19	COMPOUND RELOCATION		
E	11/07/19	REVISED PER COMMENTS		
F	11/03/20	REVISED TOWER LOCATION		
G	11/19/20	REVISED GRAVEL ACCESS		
H	05/24/21	POWER ROUTE CHANGE		
T	06/02/21	DIMENSION ADDED		
J	06/22/21	REVISED PER COMMENTS		
0	04/15/22	ISSUED FOR ZONING		



KCI TECHNOLOGIES, INC. 11830 West Market Place, Suite F Fulton, MD 20759 Phone: 410.792.8086

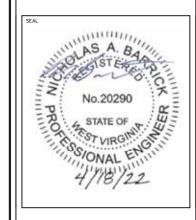

ENGINEER: NICHOLAS A. BARRICK, PE WV LICENSE NO.: 20290



HANOVER, MD 21076

KANAWHA

FA#:14878905 SITE ID#: 2544 CHARLES TOWN, WV 25414

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SCALE: AS NOTED 04/15/22

KCI JOB NUMBER: 011802184.ATT04

RF SCHEDULE AND NOTES

RF SCHEDULE AND NOTE	S
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SCALE: N.T.S.

6CC_P1prep_P2OLFN7PA1A3_P3OCWprep_P4Oprep_F0_NoDC_A 6CC_P1prep_P2OLFN7PA1A3_P3OCWprep_P4Oprep_F0_NoDC_B 21 22 40 34 20 28 37 38 51 E2 E4 54 20 00 E7 20 7060 8194 三扇 髓 體 WC S RRH 850 RRH WCS RRH FUTURE 700 B/C + 700 FN Oual Band RRM 766 B/C + 766 F/ Dual Band RRH PCS + AWS Dus Band RRH PCS + AWS Disc Band RRH 3.45 850 Optics 2 40 PCS + ANS Option 2,50 700 Optical 2 5G PC1 • AW3 Option 4,700 Option o 50 PCs o AWS Option 8.700 Optios 6CC_P1prep_P2OLFN7PA1A3_P3OCWprep_P4Oprep_F0_NoDC_C 10. 12. 11. 2 2 2 2 2 2 2 2 2 2 8888888 7000 RRH 850 RRH WCS RRH 788 B/C + 706 FN Dual Band f88H PCS + AWS Dua Band RRH RF DESIGN NOTE: THIS ANTENNA AND COAX CABLE SCHEDULE HAS BEEN CREATED USING THE FOLLOWING RFDS DATED 05/06/19 REVISION V2019_1.0 ALL ANTENNA DESIGN, ZONING, STRUCTURAL ANALYSIS PERMITS AND COMPLIANCE SUBMISSIONS ARE COORDINATED WITH THE AFOREMENTIONED DOCUMENT. 11. 4G 950 Option 11.5G 850 Optics

12.755 Optios

PCS + AWS

PCS+

DRAWN BY: JW

CHECKED BY: JM

APPROVED BY: GT

NO. DATE DESCRIPTION

A 05/23/19 PRELIMINARY DRAWINGS

B 06/06/19 REVISED PER COMMENTS

C 06/13/19 REVISED PER COMMENTS

D 10/28/19 COMPOUND RELOCATION

E 11/07/19 REVISED PER COMMENTS

F 11/03/20 REVISED PER COMMENTS

F 11/03/20 REVISED TOWER LOCATION

G 11/19/20 REVISED GRAVEL ACCESS

H 05/24/21 POWER ROUTE CHANGE


J 06/02/21 DIMENSION ADDED

J 06/22/21 REVISED PER COMMENTS

0 04/15/22 ISSUED FOR ZONING



KCI TECHNOLOGIES, INC. 11830 West Market Place, Suite F Fulton, MD 20759 Phone: 410.792.8086

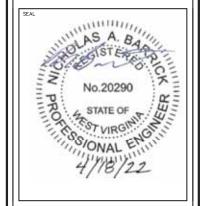

ENGINEER: NICHOLAS A. BARRICK, PE WV LICENSE NO.: 20290



7150 STANDARD DRIVE HANOVER, MD 21076

KANAWHA

FA#:14878905 SITE ID#: 2544 3557 BERRYVILLE PIKE CHARLES TOWN, WV 25414

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SCALE:	AS NOTED
DATE:	04/15/22

KCI JOB NUMBER: 011802184.ATT04

SHEET TITL

PLUMBING DIAGRAMS

SHE

A-3




700 RRH

SPECIFIC	ATIONS
LxWxD (IN.)	11.8"x15.7"x4.7"
WEIGHT (LBS.)	46

NOKIA AIRSCALE RRH 4T4R B12/14 320W AHLBA

SCALE: N.T.S.

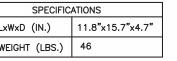


NOKIA AIRSCALE RRH 4T4R B5 160W AHCA

SCALE: N.T.S.



850 RRH

SPECIFICATIONS		
LxWxD (IN.)	13.3"x11.6"x6.5"	
WEIGHT (LBS.)	16.7	

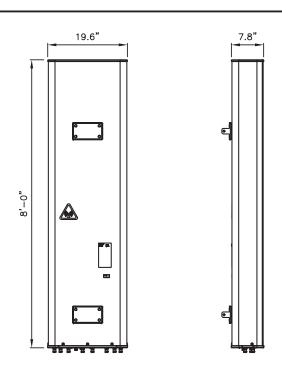



SPECIFICATIONS	
LxWxD (IN.)	96.0"x19.6"x7.8"
WEIGHT (LBS.)	121.3

PROPOSED COMMSCOPE NNHH-65C-R4

SCALE: N.T.S.


REVISED PER COMMENTS

DRAWN BY:

CHECKED BY: APPROVED BY:



KCI TECHNOLOGIES, INC. 11830 West Market Place, Suite F Fulton, MD 20759 Phone: 410.792.8086

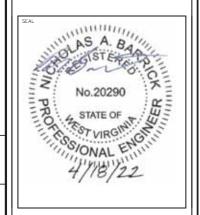

ENGINEER: NICHOLAS A. BARRICK, PE WV LICENSE NO.: 20290



HANOVER, MD 21076

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FA#:14878905 SITE ID#: 2544 CHARLES TOWN, WV 25414

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KCI JOB NUMBER: 011802184.ATT04

EQUIPMENT SPECIFICATIONS




1900 RRH


	SPECIFICATIONS		
	LxWxD (IN.)	11.8"x15.7"x4.7"	
ſ	WEIGHT (LBS.)	40	

NOKIA AIRSCALE RRH 4T4R B25/66 320W AHFIB

SCALE: N.T.S.

RF DESIGN NOTE:
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CREATED USING THE FOLLOWING RFDS DATED 05/06/19,
REVISION V2019_1.0
ALL ANTENNA DESIGN, ZONING, STRUCTURAL ANALYSIS PERMITS AND COMPLIANCE SUBMISSIONS ARE COORDINATED WITH THE AFOREMENTIONED DOCUMENT.

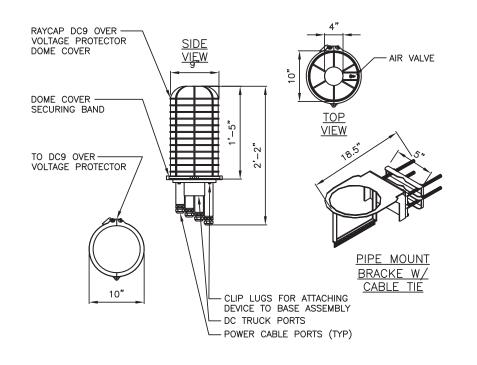

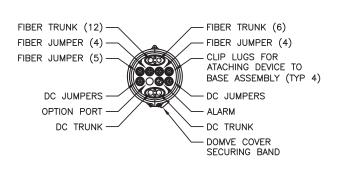

NOTES:

1. AT&T SUPPLIES DC6 SURGE
DOME AND PIPE MOUNTING
BRACKETS. CONTRACTOR SHALL SUPPLY MOUNTING PIPE OR


- 2. TOTAL WEIGHT: 32.8LBS
- 3. TOTAL WEIGHT DOES NOT INCLUDE MAST PIPE.

RAYCAP DC9 FIBER/DC DOME DETAIL

SCALE: N.T.S.



SPECIFICATIONS		
LxWxD (IN.)	26"x24"x8.8"	
WEIGHT (LBS.)	56.3	

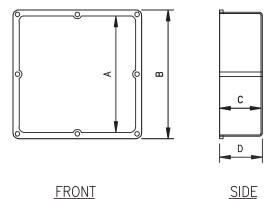

PRODUCT CODE	PART NUMBER	Α	В	С	D	GASKET CODE	SCREW CODE	VOLUME
078250	JB12124	12"	12.687"	4"	4.25"		(2)	577.4 CID
078251	JB12126	12"	12.687"	6"	6.25"	072749	072513 (8) 072549 (4)	846.0 CID
078252	JB12128	12"	12.687"	8"	8.25"		1,102.0 CID	

FIBER/DC SLACK BOX DETAIL


SCALE: N.T.S.

3

DRAWN BY: CHECKED BY: APPROVED BY: NO. DATE DESCRIPTION C 06/13/19 REVISED PER COMMENTS
D 10/28/19 COMPOUND RELOCATION REVISED PER COMMENTS REVISED TOWER LOCATION REVISED GRAVEL ACCESS POWER ROLLTE CHANGE



KCI TECHNOLOGIES, INC. 11830 West Market Place, Suite F Fulton, MD 20759 Phone: 410.792.8086

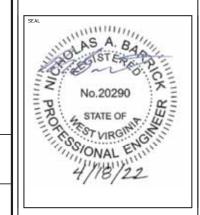

ENGINEER: NICHOLAS A. BARRICK, PE WV LICENSE NO.: 20290



HANOVER, MD 21076

KANAWHA

FA#:14878905 SITE ID#: 2544 3557 BERRYVILLE PIKE CHARLES TOWN, WV 25414

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SCALE:	AS NOTED
DATE:	04/15/22

KCI JOB NUMBER: 011802184.ATT04

EQUIPMENT SPECIFICATIONS

A-5

DC12-48-60-0-25E DETAIL SCALE: N.T.S.

2