

Architect:

Harne Bowen Architects and Planners 12509 Wolfsville Road Myersville, MD 21773

REVISIONS						
Vo.	Revisions	Date				
1.	Per comments by City of Charles Town	9-17-2007				
2.	Waterline, grading, & comments revision (per City CT & View Eng.)	10-26-2007				
3.	Per WVDOH comments	11-07-2007				
4.	Per WVDEP (Twila Carr) comments	01-15-2008				
5.	Deed Reference per City CT comments	03-27-2008				
6.	Parking add'n on Grove Prop./4 stories	03-27-2009				
7.	Comment Revisions	04-23-2009				

INDEX	
Coversheet —	1
Overall Sheet —	2
Plan Sheet —	3
E&S Sheet —	4
SWM Sheet —	5
Road Plan & Profile Sheet —	6
Details —	7-8
Landscaping & Lighting Sheet ————	9
Landscaping Details ————	10

SURVEYORS CERTIFICATE

I, Karen K. Brill, a duly registered Professional Surveyor in the State of West Virginia, do hereby certify that I have carefully surveyed the property delineated by this plat and that it is correct to the best of my knowledge and belief, that it is part of the same land in the name of MSA Inc., and recorded in the Land Records of Jefferson County, in D.B. 943, P463; D.B. 939 P. 457; D.B. 1046 P. 642.

I further certify that the lots are properly and accurately described and are within the boundary of said land; that the monuments and markers will be placed as shown hereon.

> Karen K. Brill, PS 304-725-4572 Dewberry & Davis, LLC

THE CONTRACTOR SHALL NOTIFY THE FOLLOWING AT LEAST TWO WORKING DAYS BEFORE STARTING ANY CONSTRUCTION: MISS UTILITY - CALL TOLL FREE 1-800-245-4848 ALLEGHENY POWER.. .1-301-695-5700 CITY OF CHARLES TOWN ..1-304-725-2311 JEFFERSON COUNTY PSD. ..1-304-725-4647 JEFFERSON UTILITIES INC. .1-304-725-9140

VARIANCES

The Charles Town Board of Zoning Appeals approved a variance application for the subject property on August 28, 2007, following a public hearing held on August 21, 2007. In summary, the BZA approved the following variances: Variance # 1: A minimum 5' side setback (no variance

neccesary for front variance requested in application).

Variance # 2: A minimum 22' aisle width.

Variance # 3: A minimum of 84 parking spaces

WEST VIRGINIA DEPT. OF HIGHWAYS.. ..1-304-725-5821 GARBAGE COLLECTION: APPLE VALLEY WASTE. ..1-304-267-1280 TELEPHONE: FRONTIER COMMUNICATIONS. ..1-888-535-4354 (304-728-8500) CABLE TV: GS COMMUNICATIONS, INC. .1-304-725-9185 COMCAST BUSINESS... ..1-800-316-1619 POLICE/FIRE/RESCUE.

Site Plan showing

THE GATEWAY BUILDING, LLC

City of Charles Town Jefferson County, West Virginia

CTC M2A P2, 3, 5, 6, 7, & 12 DB 943 P. 463; DB 939 P.457; DB 1046 P. 642 Owned By:

MSA, Inc. March 2009 Prepared By:



Planning Commission President

Dewberry

Dewberry & Davis, LLC

401 S. FAIRFAX BOULEVARD, SUITE 3 RANSON, WV 25438-1611 PHONE: 304.725.4572 FAX: 304.725.6896 WWW.DEWBERRY.COM

	ENGINEER'S CERTIFICATION
This plat meets the requirements of the subdivision ordinance of the y of Charles Town and has been approved for recordation by the City of Charles Town Planning Commission.	I hereby certify that these sealed plans reasonably meet acceptable engineering standards and those state a provisions applicable on said date.
	Lisa D. McCauley, PE

File Number

IEER'S CERTIFICATION ealed plans reasonably meet or exceed minimum standards and those state and county code

Lisa D. McCauley, PE 304-725-4572 Dewberry & Davis, LLC


OWNER'S STATEMENT OF ACCEPTANCE	
e Developer/Owner/Builder, in signing this Site Plan, agrees to abide to all conditions, specifications, and terms as specified from hereon.	

MSA, Inc. Peter Chakmakian, President P.O Box 547 Charles Town, WV 25414

SHEET 1 OF 10

SITE PLAN REFERENCE

STPL 2009-0003

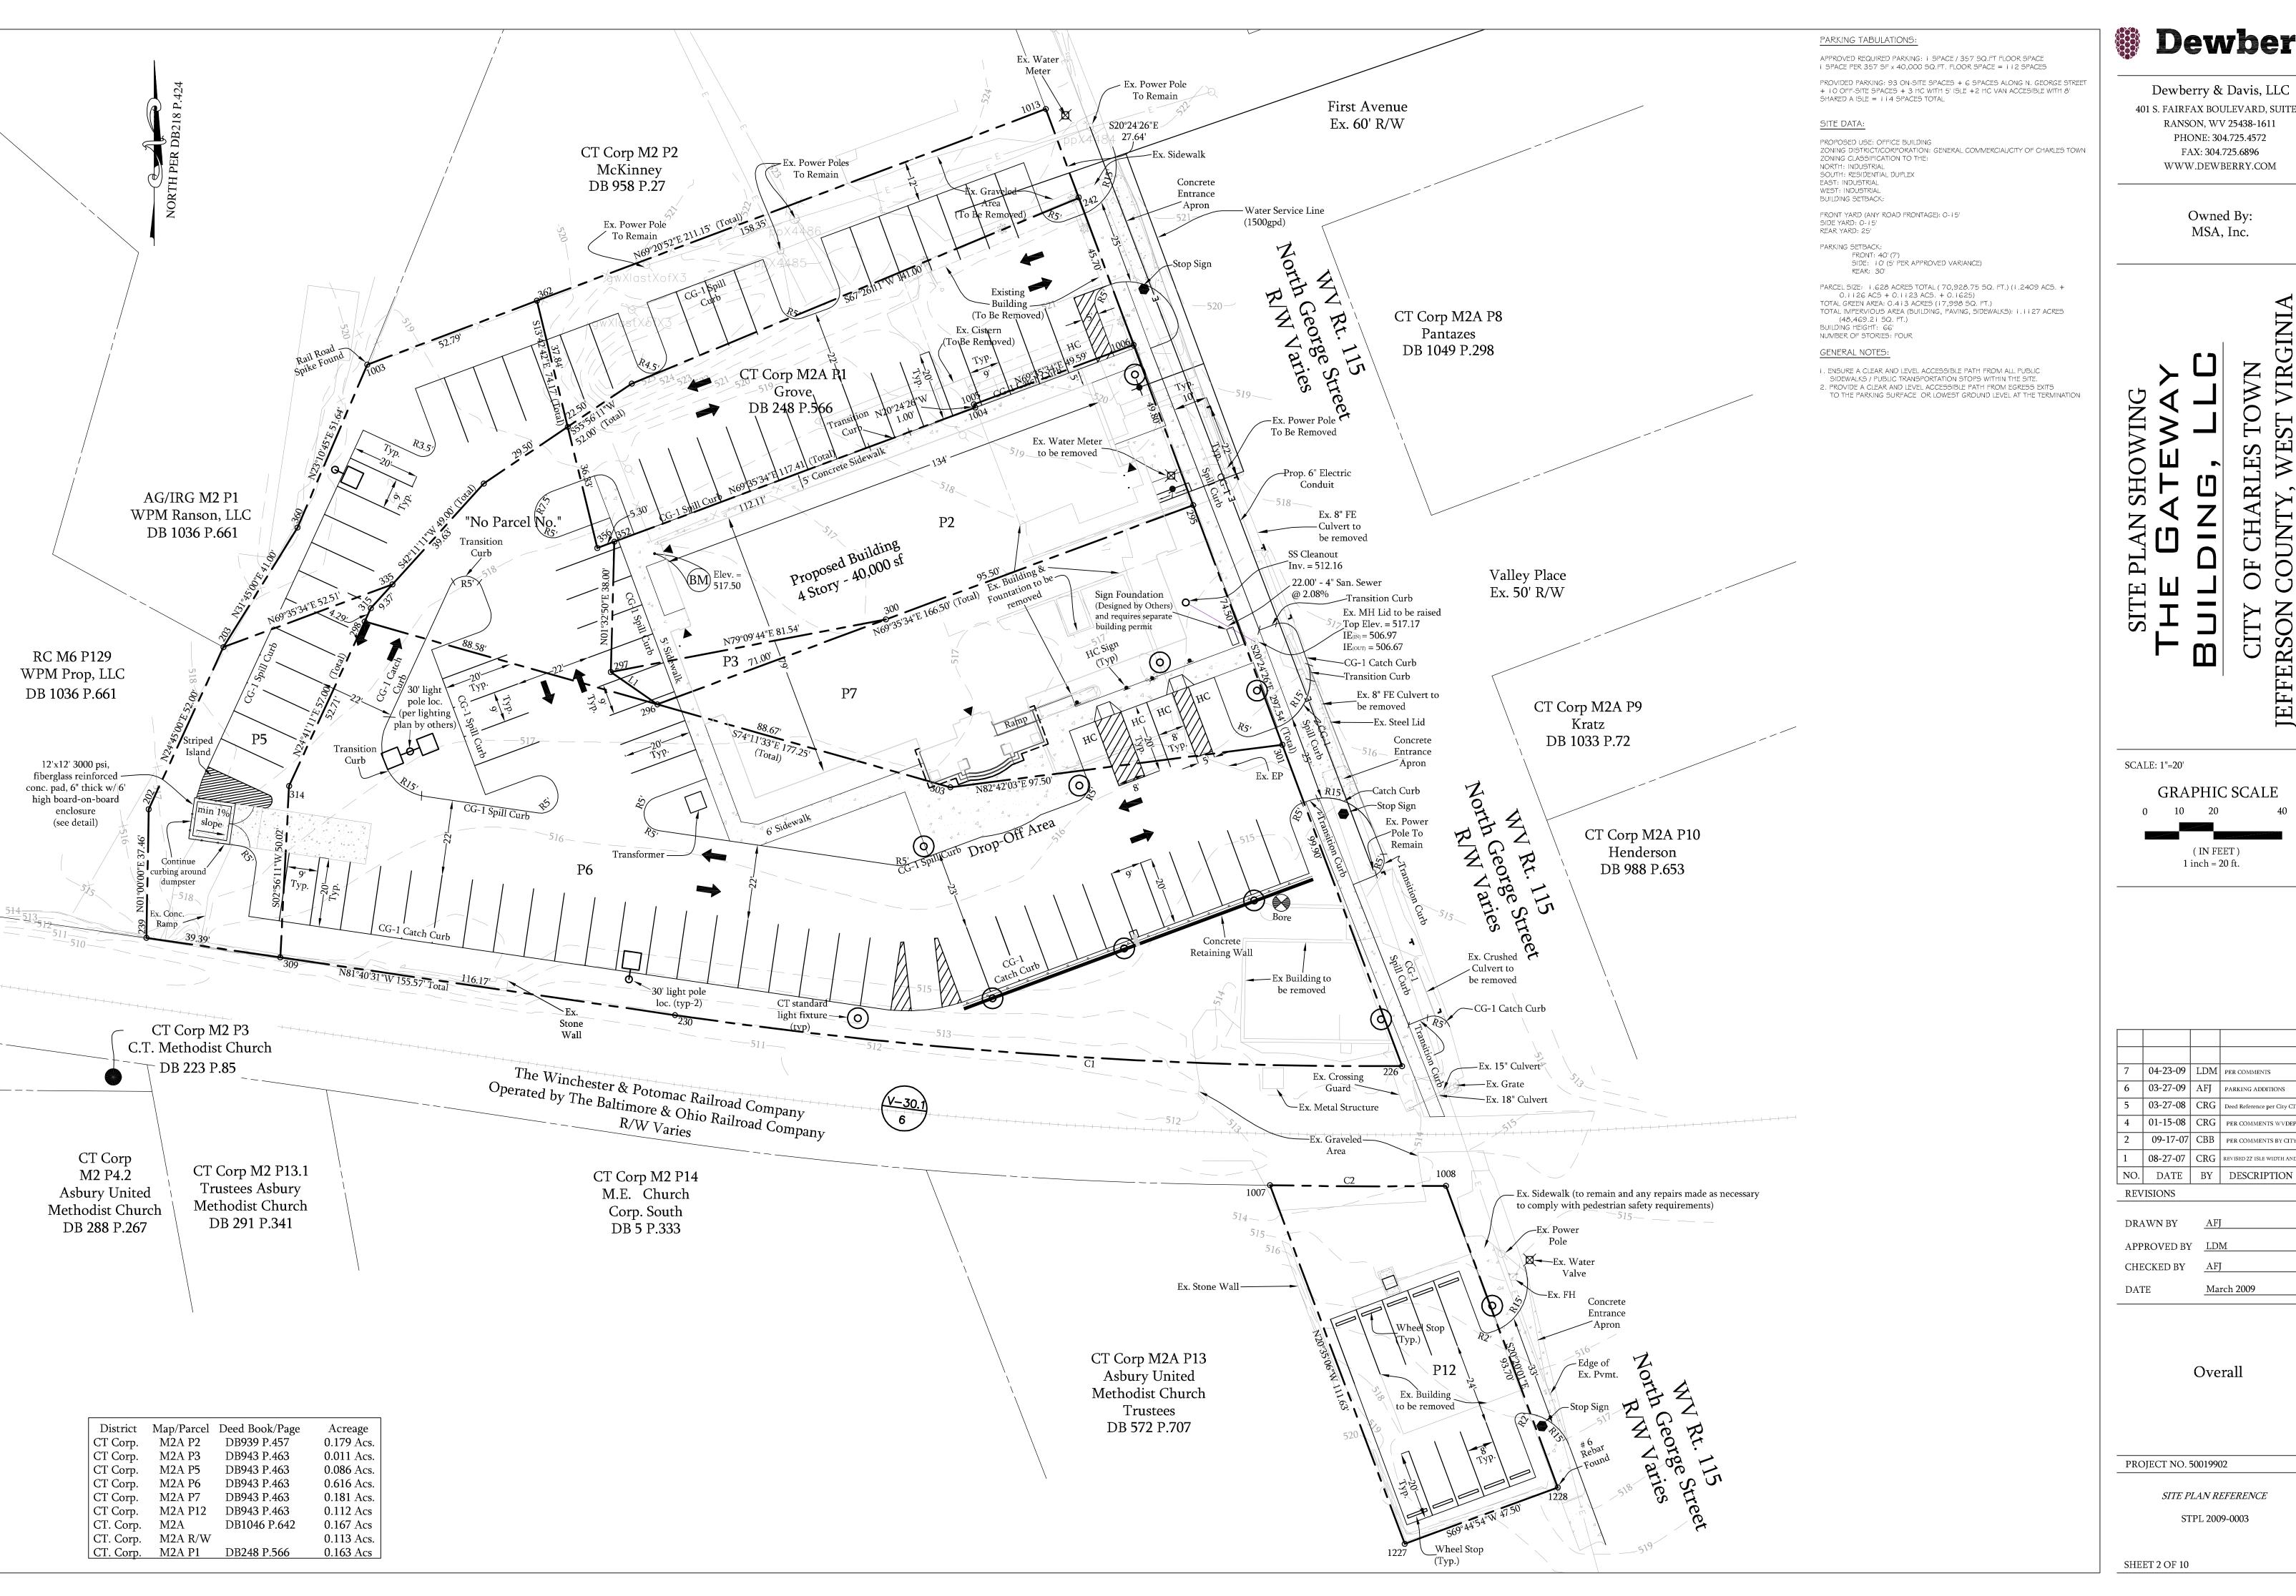



Dewberry & Davis, LLC 401 S. FAIRFAX BOULEVARD, SUITE 3 RANSON, WV 25438-1611 PHONE: 304.725.4572 FAX: 304.725.6896 WWW.DEWBERRY.COM

> Owned By: MSA, Inc.

SCALE: 1"=20'

(IN FEET) 1 inch = 20 ft.

7 | 04-23-09 | LDM | PER COMMENTS 6 03-27-09 AFJ PARKING ADDITIONS 5 03-27-08 CRG Deed Reference per City CT commer 4 01-15-08 CRG PER COMMENTS WVDEP (T. CARR) 2 09-17-07 CBB PER COMMENTS BY CITY OF CT 1 08-27-07 | CRG | REVISED 22' ISLE WIDTH AND 5' BRL

REVISIONS

DRAWN BY APPROVED BY

CHECKED BY


Overall

PROJECT NO. 50019902

SITE PLAN REFERENCE

STPL 2009-0003

SHEET 2 OF 10

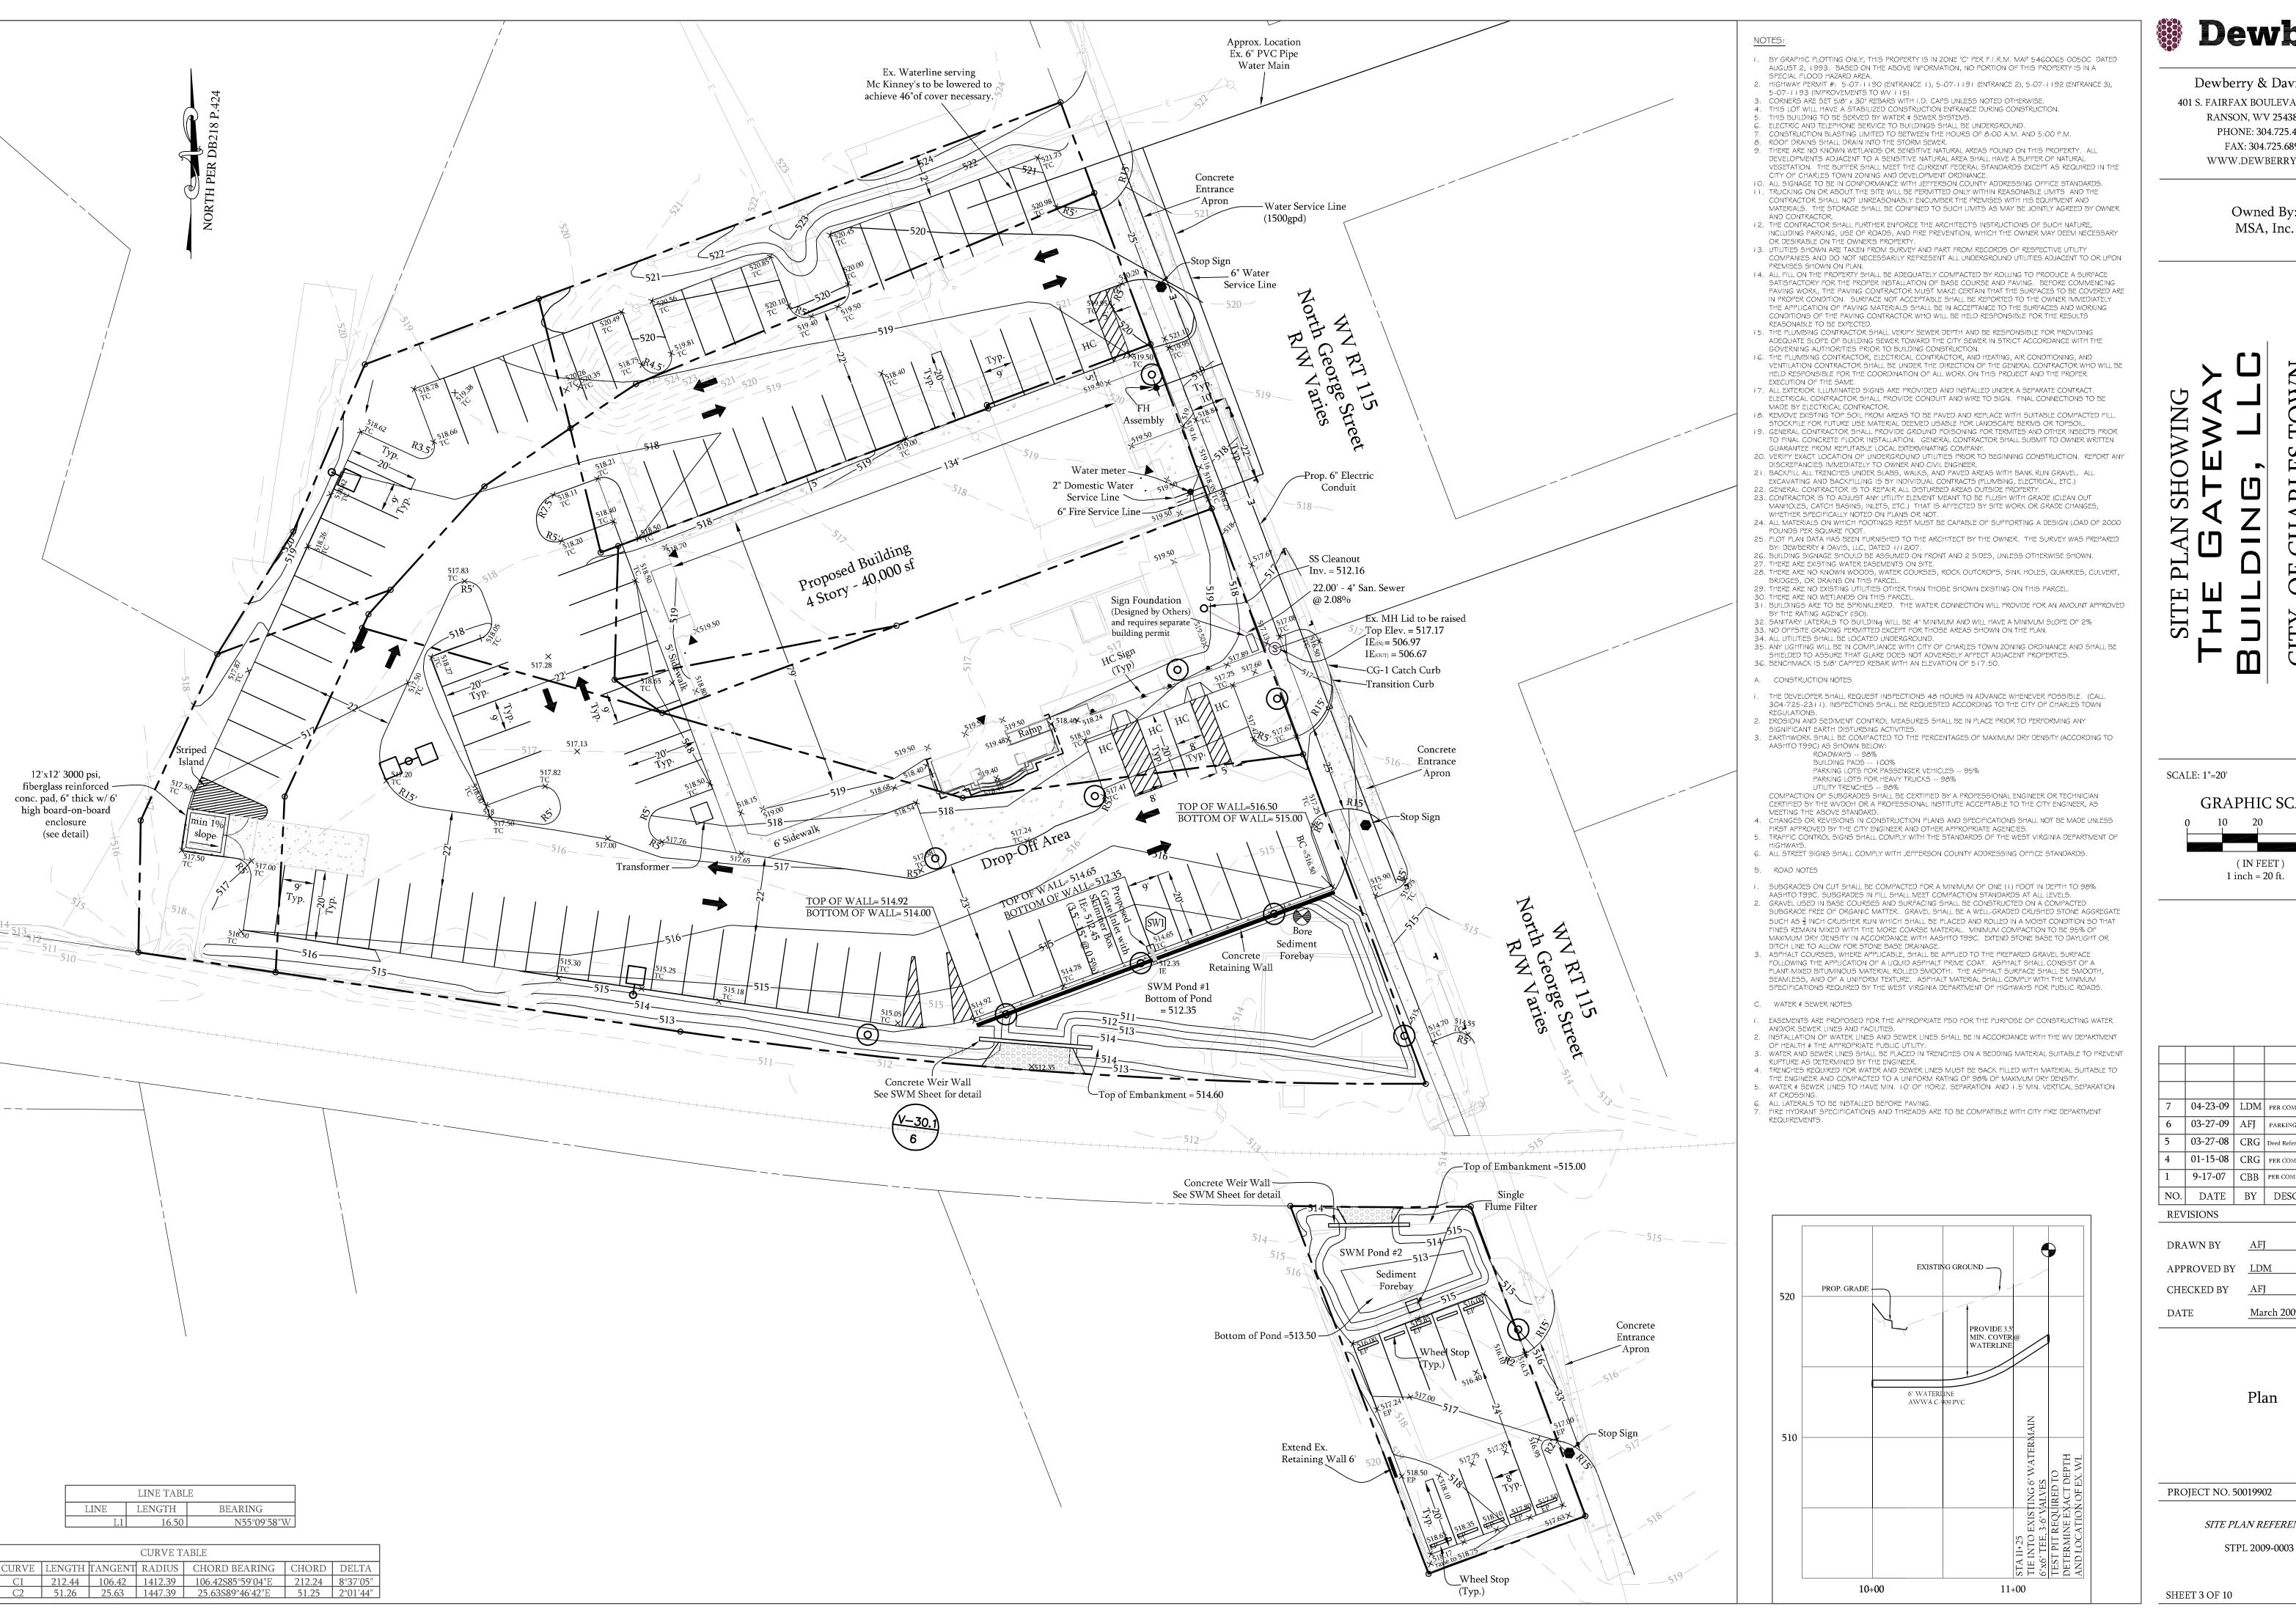

Dewberry

Dewberry & Davis, LLC 401 S. FAIRFAX BOULEVARD, SUITE 3 RANSON, WV 25438-1611 PHONE: 304.725.4572 FAX: 304.725.6896 WWW.DEWBERRY.COM

Owned By:

SCALE: 1"=20'

GRAPHIC SCALE (IN FEET) 1 inch = 20 ft.

04-23-09 | LDM | PER COMMENTS 6 03-27-09 AFJ PARKING ADDITIONS 03-27-08 | CRG | Deed Reference per City CT commo 4 | 01-15-08 | CRG | PER COMMENTS WVDEP (T. CARR) 1 9-17-07 CBB PER COMMENTS BY CITY OF CT NO. DATE BY DESCRIPTION

PROJECT NO. 50019902

SITE PLAN REFERENCE



SEQUENCE OF CONSTRUCTION

- 1. INSTALL STABILIZED CONSTRUCTION ENTRANCE AND ALL PERIMETER EROSION AND SEDIMENT CONTROL DEVICES PRIOR TO ANY OTHER LAND DISTURBING ACTIVITY. (1 week)
- 2. CONSTRUCT STORM WATER MANAGEMENT POND 1 TO SERVE AS TEMPORARY SEDIMENT BASIN. (1 week) 3. CONSTRTUCT STORM WATER MANAGEMENT POND 2 TO SERVE AS TEMPORARY SEDIMENT BASIN REPLACING THE WEIR WALL FOR A RIPRAP OUTLET SEDIMENT TRAP AS PER DETAIL PROVIDED. (1 week)
- 4. CLEAR REMAINING OF SITE INSIDE THE LIMITS OF CLEARING AND GRADING. (1 week) 5. CONSTRUCT COMPACTED SUBGRADE. (1 week)
- 6. CONSTRUCT WATER LINES AND SANITARY SEWER LINES. (1 week)
- 7. CONSTRUCT STORM SEWER WITH INLET PROTECTION. (1 week) 8. CONSTRUCT TRAVEL WAY AND PARKING AREAS. (2 weeks)
- 9. STABILIZE AREAS SURROUNDING TRAVEL WAY AND PARKING AREAS. (1 week)
- 10. CONSTRUCT BUILDING AND STABILIZE THE SURROUNDING AREAS. (20 weeks) 11. STABILIZE ALL REMAINING AREAS. (1 weeks)
- 12. MUCK OUT SEDIMENT BASIN ON BOTH PONDS; REMOVE E&S STANDPIPE FROM POND 1; REMOVE RIPRAP OUTLET SEDIMENT TRAP FROM POND 2; CONSTRUCT WEIR WALL PER DESIGN; INSTALL EXTENDED DETENTION DEVICES PER DESIGN AND CONVERT TO PERMANENT STORM WATER MANAGEMENT. (1 week)

SEDIMENT CONTROL NOTES

- 1. EROSION AND SEDIMENT CONTROL DEVICES TO BE IN PLACE PRIOR TO ANY CONSTRUCTION. MINIMIZE EXPOSURE OF DISTURBED SOIL.
- 2. ALL STOCK PILES ON SITE, DURING CONSTRUCTION SHALL BE SURROUNDED BY SILT FENCE TO PROVIDE EROSION AND SEDIMENT CONTROL.
- 3. DURING CONSTRUCTION, ALL SEDIMENT TRAPPING STRUCTURES MUST BE INSPECTED EVERY SEVEN DAYS AND AFTER 0.5" OR GREATER OF PRECIPITATION, AND REPAIRED, IF NECESSARY. SEDIMENT TO BE REMOVED TO A SUITABLE DISPOSAL AREA AND STABILIZED WITH PERMANENT VEGETATION COVER.
- 4. TO KEEP EROSION AND SEDIMENTATION TO A MINIMUM, DISTURB AS LITTLE EARTH AS POSSIBLE DURING ALL PHASES OF CONSTRUCTION. 5. CONTRACTOR IS RESPONSIBLE FOR MAINTAINING ALL SEDIMENT AND EROSION CONTROL
- MEASURES UNTIL DISTURBED AREAS ARE STABILIZED. 6. AFTER FINE GRADING, ALL DISTURBED AREAS ARE TO BE PERMANENTLY MULCHED AND SEEDED.
- 7. NO SLOPE SHALL BE GREATER THAN 2:1. 8. ALL EXPOSED AREAS TO BE COVERED WITHIN WEEK OF FINAL GRADING. SEED SLOPES OF 3:1 OR STEEPER WITH KY BLUEGRASS. SEED WITH A MIX OF 35 POUNDS OF KENTUCKY 31 FESCUE
- AND 15 POUNDS PERENNIAL RYEGRASS PER ACRE. LIME WITH 1 TON OF GROUND LIMESTONE PER ACRE. FERTILIZE WITH 1000# OF 10-10-10- PER ACRE. 9. EXCEPT AS NOTED BELOW, STABILIZATION MEASURES SHALL BE INITIATED AS SOON AS PRACTICABLE
- IN PORTIONS OF THE SITE WHERE CONSTRUCTION ACTIVITIES HAVE TEMPORARILY OR PERMANENTLY CEASED, BUT IN NO CASE MORE THAN 7 DAYS AFTER THE CONSTRUCTION ACTIVITY IN THAT PORTION OF
- THE SITE HAS TEMPORARILY OR PERMANENTLY CEASED. A.) WHERE THE INITIATION OF STABILIZATION MEASURES BY THE 7TH DAY AFTER CONSTRUCTION ACTIVITY TEMPORARY OR PERMANENTLY CEASES IS PRECLUDED BY SNOW COVER, STABILIZATION MEASURES SHALL BE INITIATED AS SOON AS CONDITIONS ALLOW.
- B.) WHERE CONSTRUCTION ACTIVITY WILL RESUME ON A PORTION OF THE SITE WITHIN 21 DAYS FROM WHEN ACTIVITIES CEASED. (E.G. THE TOTAL PERIOD THAT CONSTRUCTION ACTIVITIES HAVE
 - SWM POND LOW MAINTENANCE SEED MIX CANADIAN BLUE GRASS 20 LB/AC. ATILLA HARD FESCUE 15 LB/AC. KY. BLUE GRASS BIRDSFOOT TREFOL 5 LB/AC. NE WILDFLOWER MIX 6 LB/AC.
- FERTILIZER SHALL BE APPLIED AT THE RATE OF 1000 LBS/AC. USING 10-10-10 OR EQUIVALENT. ACID SOILS SHALL BE LIMED.
- MULCH SHALL BE APPLIED IMMEDIATELY AFTER SEEDING. MULCH MATERIALS AND APPLICATIONS SHALL CONFORM TO THE STANDARDS SPECIFICATIONS.
- MULCHING: MULCH ALL AREAS FOR TEMPORARY EROSION CONTROL AND MOISTURE RETENTION. MULCH MAY BE STRAW OR HAY, WOOD FIBER, OR MULCH NETTING. APPLY STRAW OR WEED-FREE HAY AT TWO TONS PER ACRE (100 POUNDS PER 1,000 SQUARE FEET). APPLY WOOD FIBER AT 1,000 TO 2,000 POUNDS PER ACRE (25 TO 50 POUNDS PER 1,000 SQUARE FEET). APPLY MULCH NETTING ACCORDINGLY TO MANUFACTURER'S RECOMMENDATIONS.
- TEMPORARY AND PERMANENT SEEDING SPECIFICATIONS: ALL EXPOSED AREAS TO BE COVERED WITHIN WEEK OF FINAL GRADING, SEED SLOPES OF 3:1 OR STEEPER WITH KENTUCKY BLUEGRASS. SEED WITH A MIX OF 35 POUNDS OF KENTUCKY 31 FESCUE AND 15 POUNDS PERENNIAL RYE GRASS PER ACRE. FERTILIZE WITH 1000 LBS. OF 10-10 PER ACRE. INSTALL STRAW BALES AT COMPLETION OF ROUGH GRADING, TO REMAIN IN PLACE UNTIL STABILIZATION OF GROUND IS EVIDENCED.
- 10. STABILIZATION WILL BE CONSIDERED ADEQUATE WHEN THE FOLLOWING CONDITIONS HAVE BEEN MET:
 - A. WATER COURSES, STREAM BANKS, AND DRAINAGE EASEMENTS ARE 100% STABLE AND FREE OF EROSION AND SEDIMENTATION.
 - B. SLOPES STEEPER THAN 10% SHALL HAVE AT LEAST 98% STABLE GROUND
- C. ALL AREAS SHALL HAVE AT LEAST 85% STABLE GROUND COVER. D. GRASS VEGETATION SHALL HAVE REACHED A MINIMUM OF 3" TALL OR BEEN
- MOWED BACK TO A MINIMUM OF 2" TALL.
- E. VEGETATION COVERS OTHER THAN GRASSES SHALL HAVE SURVIVED ONE
- 11. FOLLOWING INITIAL SOIL DISTURBANCE OR RE-DISTURBANCE, PERMANENT OR TEMPORARY STABILIZATION SHALL BE COMPLETED WITHIN SEVEN (7) CALENDAR DAYS. 12. TOPSOIL STOCK PILES SHALL HAVE SILT FENCE PLACED AROUND THE DOWNHILL SIDE OF THE STOCKPILE.


Dewberry

Dewberry & Davis, LLC

401 S. FAIRFAX BOULEVARD, SUITE 3 RANSON, WV 25438-1611 PHONE: 304.725.4572 FAX: 304.725.6896 WWW.DEWBERRY.COM

Owned By:

SCALE: 1"=20'

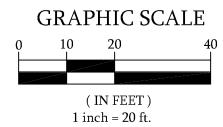

04-23-09 | LDM | PER COMMENTS 6 03-27-09 AFJ PARKING ADDITIONS 1 9-17-07 CBB PER COMMENTS BY CITY OF CT NO. DATE BY DESCRIPTION

REVISIONS

DRAWN BY APPROVED BY

CHECKED BY DATE


E&S

PROJECT NO. 50019902

SITE PLAN REFERENCE

STPL 2009-0003

SHEET 4 OF 10

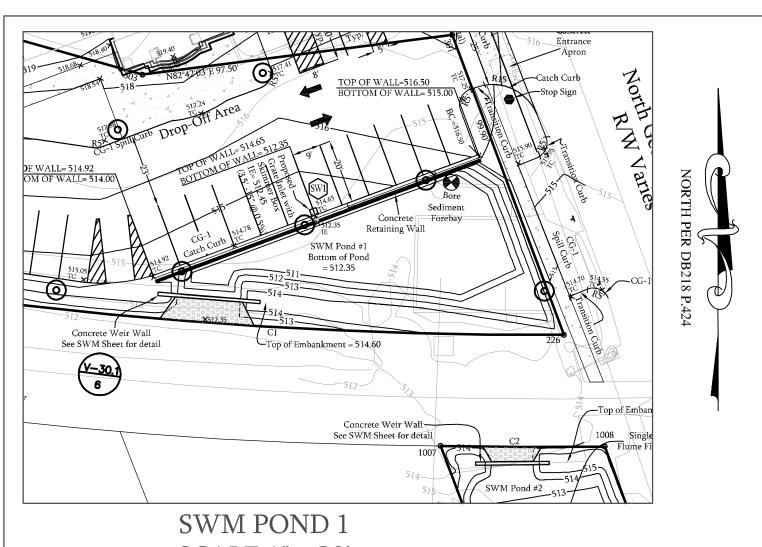

SCALE 1'' = 30'

REQUIRED STORAGE IN FOREBAY= 0.1 INCHES PER IMPERV. ACRE= 382 CF OF STORAGE REQUIRED


SEDIMENT FOREBAY COMPUTATIONS


IMPERVIOUS AREA = 1.05 ACRES


2850 CF OF STORAGE PROVIDED

Sediment Forebays for Pond								
Storage Volumes								
Elevation	Area	Avg Area	Depth	Inc. Vol.	Total Vol.	Total Vol.		
	sft	sft	ft	cft.	cft	ac.ft.		
511.00	1910				0	0.000		
		1961	0.35	686				
511.35	2013				686	0.016		
		2163	1.00	2163				
512.35	2314				2850	0.065		

THE SEDIMENT FOREBAY WILL BE LINED WITH BEND TARP PPL-24.

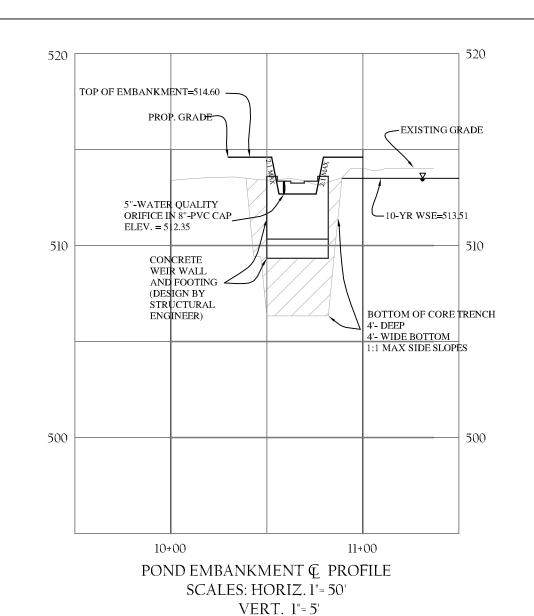

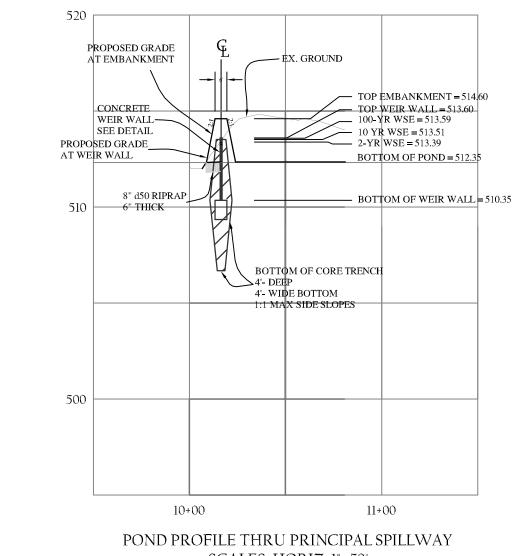


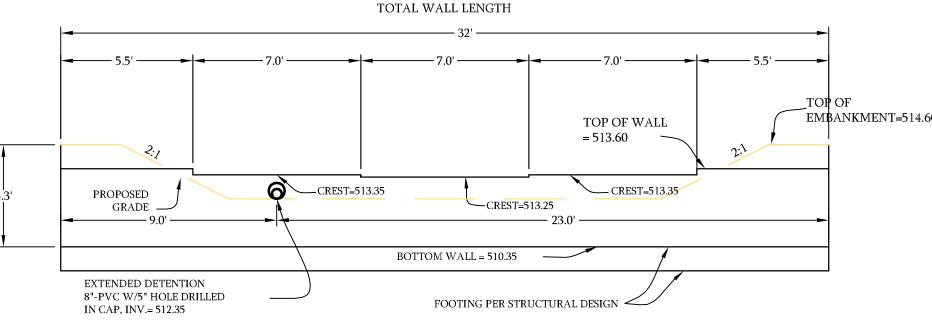



TOP OF

EMBANKMENT=515.00

POND WEIR WALL DETAIL SCALE = 1"=4"

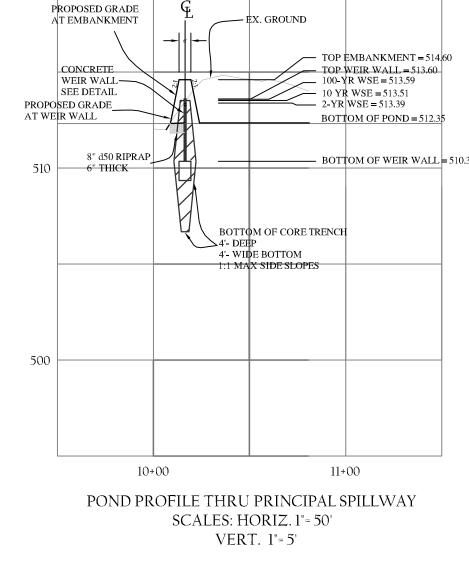

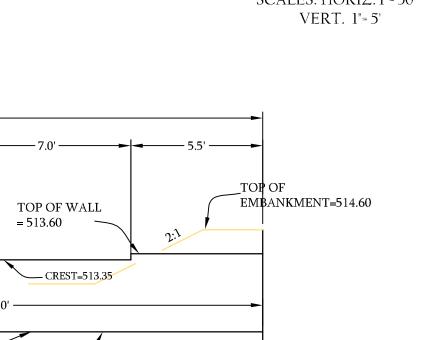

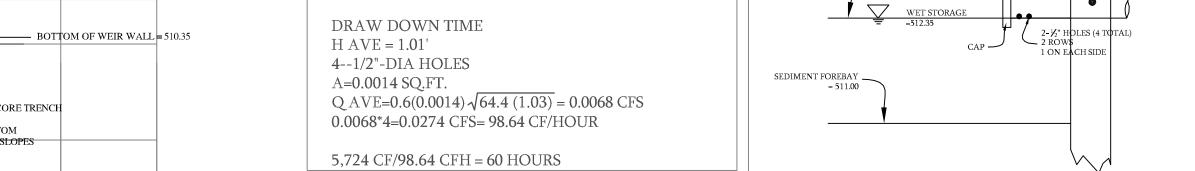

-ATTACH WITH COATED

-3/4" EXTERIOR

MASONRY

GRADE

PLYWOOD

NAILS

≥1/2" ANCHOR

GRADE

PLYWOOD

Trash Rack Detail

NTS

SEDIMENT BASIN COMPUTATIONS

1.59 ACS. x 3600 CF/AC. = 5,724 CF

1.59 ACS. x 1800 CF/AC. "WET" STORAGE = 2,862 CF

OCCURS AT ELEVATION 513.36

OCCURS AT ELEVATION 512.33

WITH $\frac{3}{4}$ " PLYWOOD (AS SHOWN).

USE OF WEIR WALL FOR TEMPORARY SEDIMENT BASIN

MASONRY NAILS. UPON CONVERSION OF TEMPORARY

MATERIAL, ANY HOLES RESULTING FROM THE USE OF

NTS

REOUIRES DRILLING PILOT HOLES INTO WEIR WALL FOR

MANAGEMENT FACILITY, GROUT OR FILL WITH APPROVED


MASONRY NAILS, ALSO, UPON CONVERSION TO PERMANENT

PVC PIPE AND THE 5" ORIFICE HOLE WILL BE DRILLED INTO

SWM, THE STAND PIPE WILL BE CUT AT LEAST 3 INCHES FORM THE WEIR WALL, THE CAP WILL BE PUT ON THE END OF THE

ON-SITE AREA= 1.59 ACS.

DURING CONSTRUCTION, WHILE IN USE AS TEMPORARY SEDIMENT BASIN, LOW FLOW PIPE WILL EXTEND OUT HORIZONTALLY 9 INCHES TO ACT AS A STAND PIPE IN WHICH TEMPORARY SEDIMENT BASIN $\frac{1}{2}$ " HOLES WILL BE DRILLED IN ORDER TO DRAIN THE WATER. DEWATERING STAND PIPE THE WEIR OPENINGS ON THE WEIR WALL WILL BE COVERED

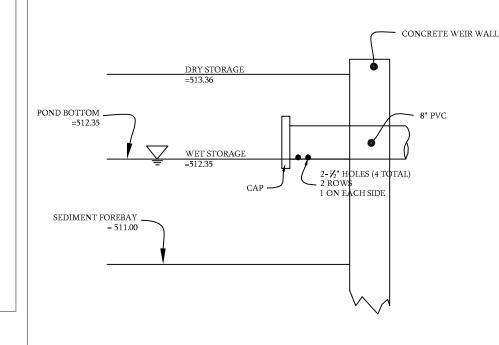

SHOWING

Dewberry

Dewberry & Davis, LLC

401 S. FAIRFAX BOULEVARD, SUITE 3

RANSON, WV 25438-1611

PHONE: 304.725.4572

FAX: 304.725.6896

WWW.DEWBERRY.COM

Owned By:


MSA, Inc.

SCALE: AS NOTED

SITE

2"x4" P.T. LUMBER STRUTS **TEMPORARY** ESC WEIR

THE CAP.

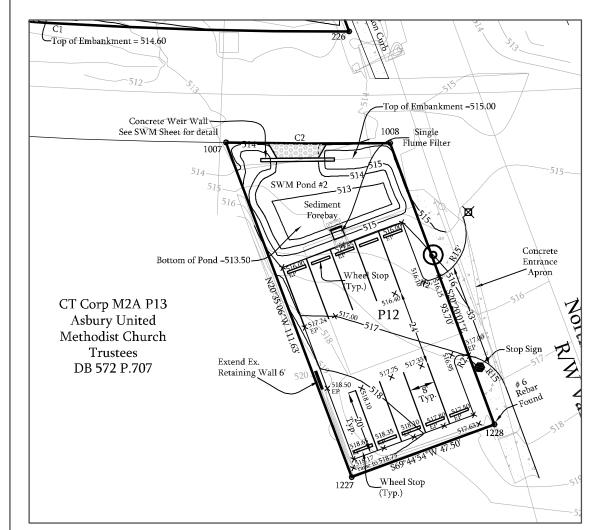

SWM POND 2 SCALE 1" = 30'


SEDIMENT FOREBAY COMPUTATIONS IMPERVIOUS AREA = .11 ACRES

REQUIRED STORAGE IN FOREBAY= 0.1 INCHES PER IMPERV. ACRE= 39.93 CF OF STORAGE REQUIRED

201 CF OF STORAGE PROVIDED

Sediment Forebays for Pond							
Storage Volumes							
Elevation	Area	Avg Area	Depth	Inc. Vol.	Total Vol.	Total Vol.	
	sft	sft	ft	cft.	cft	ac.ft.	
513.00	355				0	0.000	
		402	0.50	201			
513.50	448				201	0.005	

THE SEDIMENT FOREBAY WILL BE LINED WITH BEND TARP PPL-24.

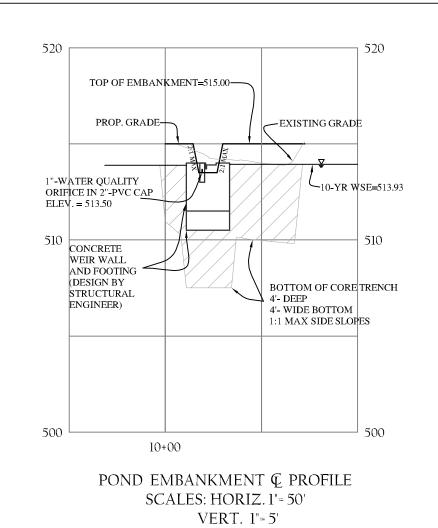

TOTAL WALL LENGTH

GRADE -

EXTENDED DETENTION / 2"-PVC W/1" HOLE DRILLED

IN CAP, INV.= 513.50 W/ "TRASH RACK"

TOP OF WALL

=514.00


-CREST=513.70


FOOTING PER STRUCTURAL DESIGN \angle


BOTTOM WALL = 511.50

POND WEIR WALL DETAIL

SCALE = 1"=4"

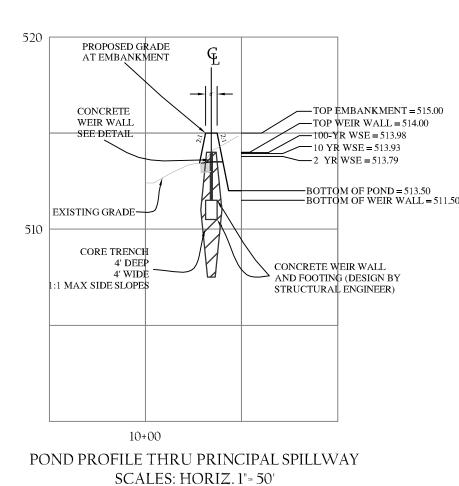

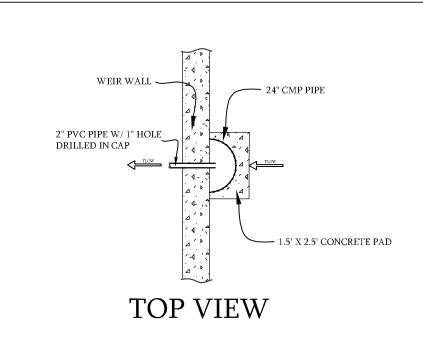

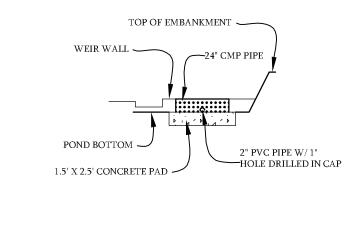

FRONT VIEW

-1.5' X 2.5' CONCRETE PAD

SIDE VIEW

DURING CONSTRUCTION, WHILE IN USE AS TEMPORARY SEDIMENT BASIN, INSTALL RIPRAP OUTLET SEDIMENT TRAP.

UPON CONVERSION OF TEMPORARY SEDIMENT BASIN TO PERMANENT STORMWATER MANAGEMENT FACILITY, REMOVE RIPRAP OUTLET SEDIMENT TRAP, CONSTRUCT WEIR WALL PER DESIGN. INSTALL EXTENDED DETENTION DEVICES INCLUDING THE 24" CMP PERFORATED PIPE CUT IN HALF TO WORK AS A TRASH RACK, PER DETIAL PROVIDED.

9-17-07 | CBB | PER COMMENTS BY CITY OF CT NO. DATE BY DESCRIPTION REVISIONS DRAWN BY APPROVED BY CHECKED BY

04-23-09 | LDM | PER COMMENTS

4 | 01-15-08 | CRG | PER COMMENTS WVDEP (T. CARF

6 | 03-27-09 | AFJ | PARKING ADDITIONS

SWM/ESC PROFILES DETAILS **NOTES**


PROJECT NO. 50019902


DATE

SITE PLAN REFERENCE


STPL 2009-0003

SHEET 5 OF 10

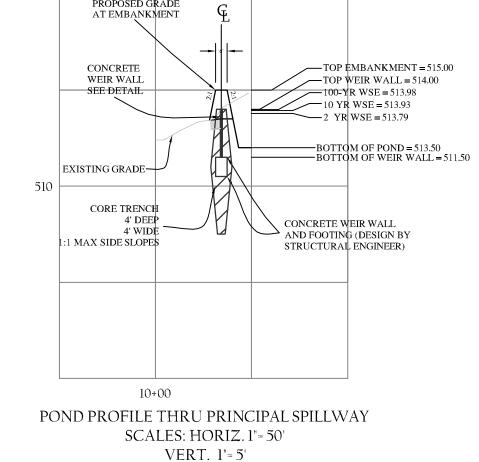


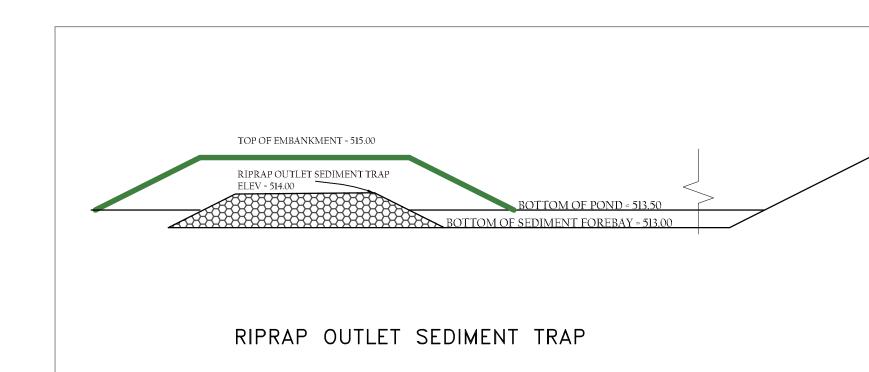


Main Entrance

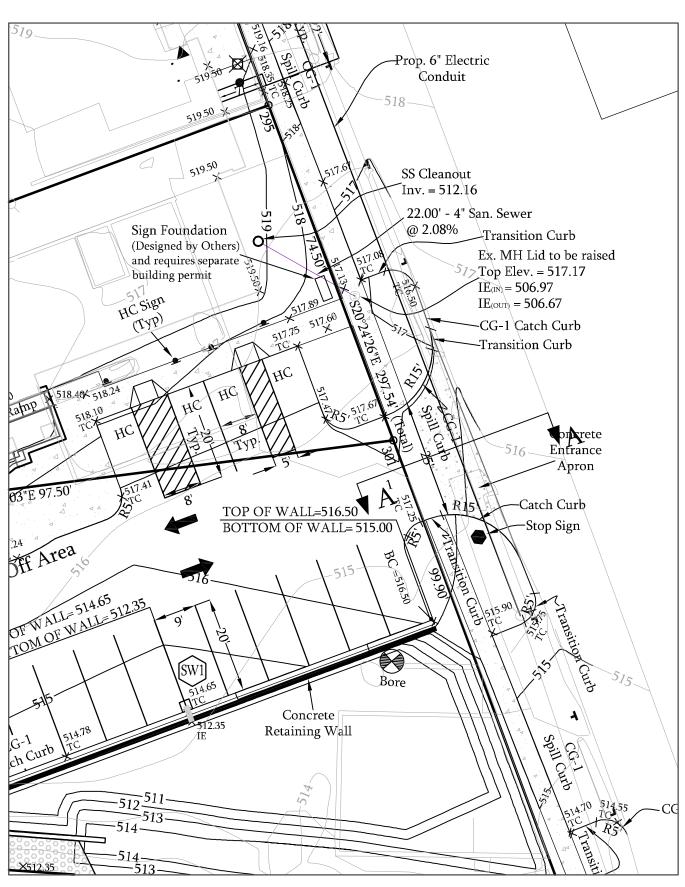

Secondary Entrance

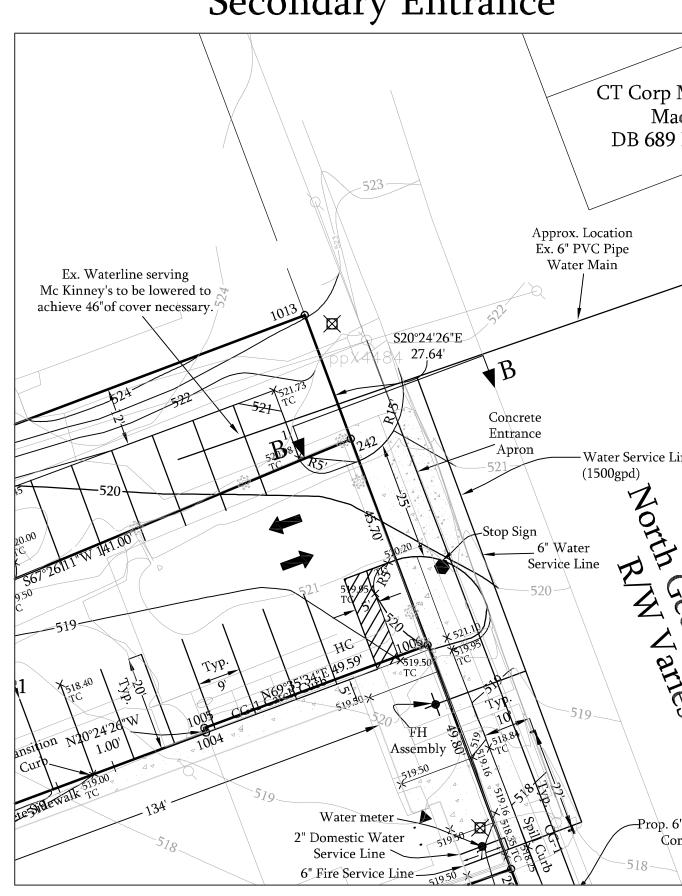


Individual Lot Entrance

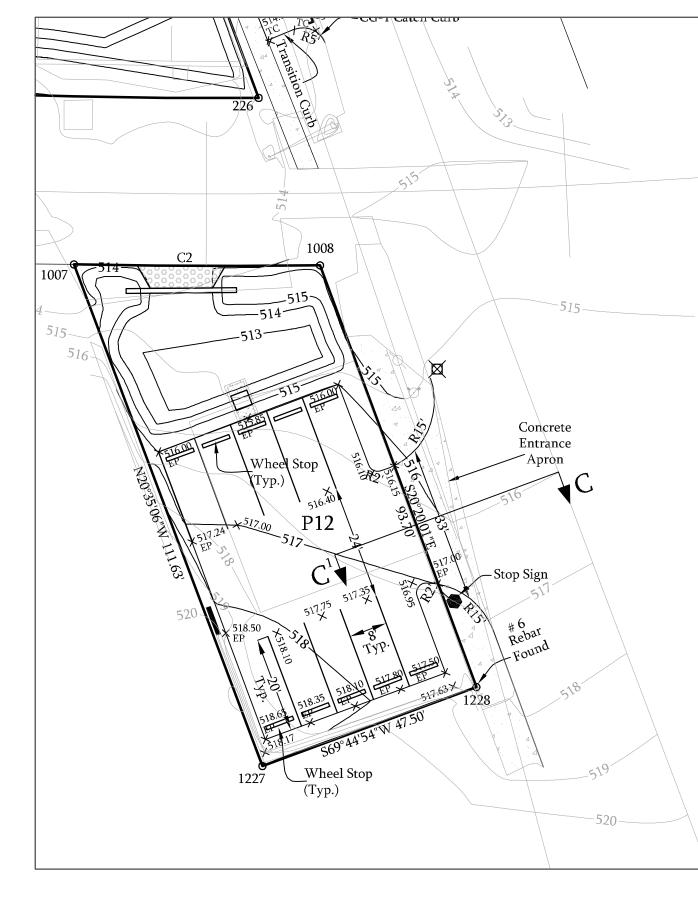



PLAN VIEW SCALE:

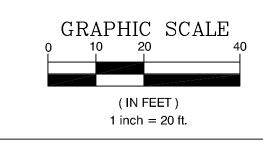


Dewberry

Dewberry & Davis, LLC


401 S. FAIRFAX BOULEVARD, SUITE 3

PHONE: 304.725.4572 FAX: 304.725.6896 WWW.DEWBERRY.COM


GATEWAY CENTER OFFICE BUILDING MAIN ENTRANCE

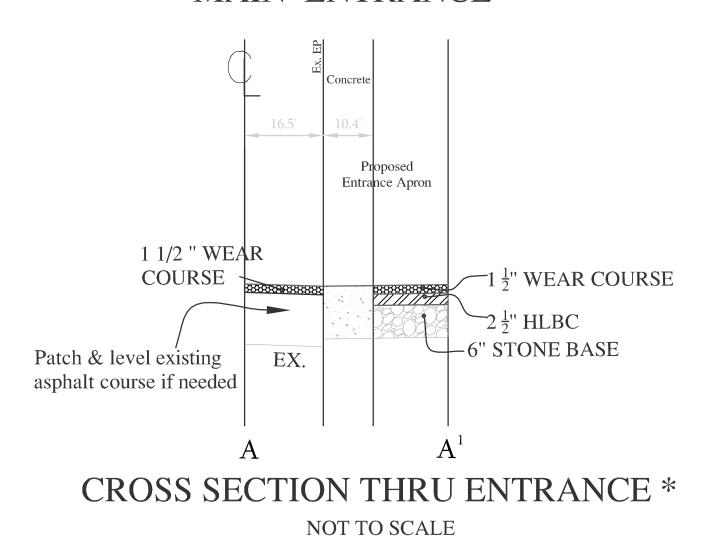

GATEWAY CENTER OFFICE BUILDING SECONDARY ENTRANCE

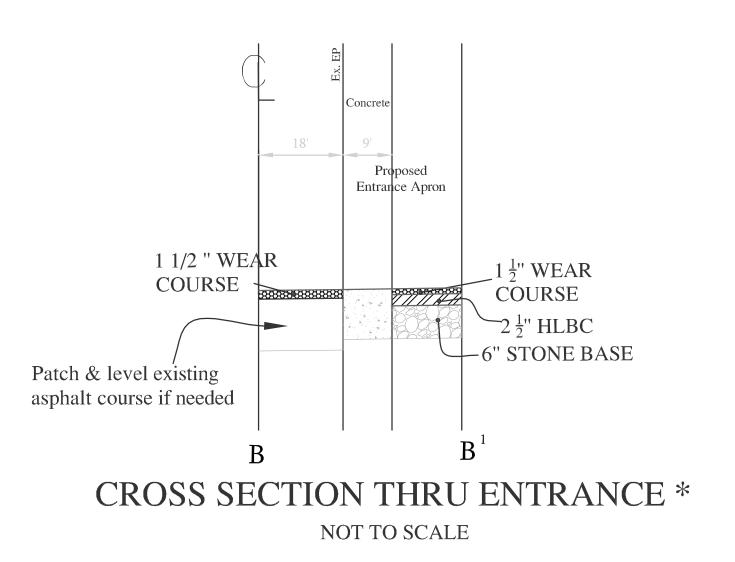

GATEWAY CENTER OFFICE BUILDING INDIVIDUAL LOT ENTRANCE

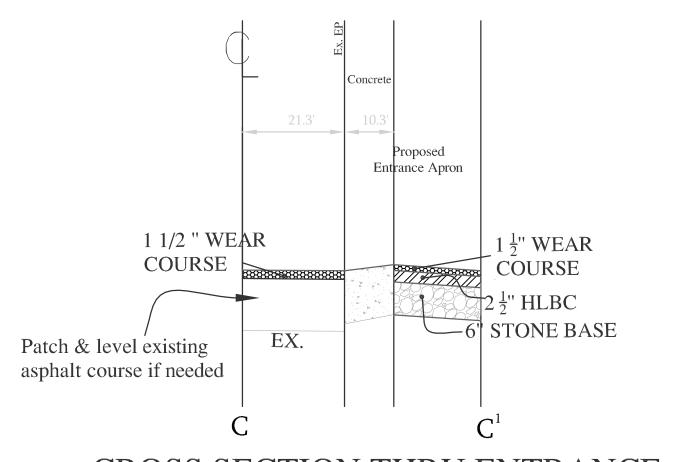

CROSS SECTION THRU ENTRANCE

NOT TO SCALE The roadway needs to be patched and leveled with asphalt if needed, and then overlay entire road for 50' on both sides.

ROAD PLAN & PROFILE ENTRANCE DETAIL

04-23-09 LDM Per comments 6 03-27-09 AFJ Parking additions

NO. DATE BY DESCRIPTION

REVISIONS

DRAWN BY

APPROVED BY

CHECKED BY

DATE

3 11-07-07 CRG Per WVDOH comments

PROJECT NO. 50019902

SITE PLAN REFERENCE

STPL 2009-0003

SHEET 6 OF 10

*The roadway needs to be patched and leveled with asphalt if needed, and then overlay entire road from 50' south east of the main entrance to 50' north west of the Secondary Entrance.



• Total site area 1.47 acres or 64,033 s.f.

• Total landscape area required = 3,202 s.f. (64,033*5%)

Total landscape area required = 3,202 s.f. (64,033*7.5%)
Total landscape area proposed = 4,791 s.f. (64,033*7.5%)
Proposed impervious Area 1.36 acres or 59,242 s.f.
Total trees required = 30 (59,242/2,000 s.f.)
Total trees provided = 30
Total shrubs required = 90
Total shrubs provided = 100

PLANTING LEGEND:
PICK 1 PLANT FROM EACH ROW & USE IT THROUGHOUT THE SITE.

	QUAN	IT. SYMBOL	BOTANICAL NAME	COMMON NAME	SIZE	COMMENTS
PERIMETER SHADE TREES	2		ACER RUBRUM ACER SACCHARUM QUERCUS SHUMARDII QUERCUS PALUSTIS	RED MAPLE SUGAR MAPLE SHUMARD OAK PIN OAK	3 INCH CALIPER 12' HT. MIN.	PER PLAN
FLOWERING MEDIUM TREES	5		KOELREUTARIA PANICULATA AMERICAN YELLOWOOD OXYDENDUM ABOREUM	GOLDEN RAINTREE AMERICAN YELLOWOOD SOURWOOD	3 INCH CALIPER 12' HT. MIN.	PER PLAN
PARKING LOT SHADE TREES	7		ACER X FREEMANII 'AUTUMN BLAZE' FRAXINUS PENNSYLVANICA 'MARSHAL'S SEEDLESS' ZELKOVA SERRATA 'GREEN VASE' ULMUS PARVIFOLIA	FREEMAN MAPLE 'MARSHAL'S SEEDLESS' GREEN ASH GREEN VASE ZELKOVA LACE BARK ELM	3 INCH CALIPER 12' HT. MIN.	PER PLAN
Holly TREES	4		ILEX X 'NELLIE R. STEVENS' ILEX X ATTENUATA 'FOSTER'S' ILEX DECIDUA (DECIDUOUS)	NELLIE R. STEVENS HOLLY FOSTER'S HOLLY POSSUMHAW	8-10' HT., B & B	8' O.C.
POTTED COLUMNAR JUNIPER TREES	9		JUNIPERUS SCOPULARUM 'SKYROCKET' JUNIPERUS VIRGINIANA 'SPARTAN' THUJA OCCIDENTALIS 'SMARGARD'	'SKYROCKET' JUNIPER 'SPARTAN' UNIPER 'SMARGARD' ARBORVITAE	8' HT., CONTAINER GROWN	HOME DEPOT OR EQUAL 36" DIAMETER NON-BREAKA DECORATIVE PLANTER PER LANDSCAPE ARCHITECT
FLOWERING DECID. SHRUBS	4	e	BERBERIS THUNBERGII 'AUREA' BUDDLEIA DAVIDII 'PINK DELIGHT' SPIRAEA X BUMALDA "ANTHONY WATERER'	JAPANESE BARBERRY 'PINK DELIGHT' BUTTERFLY BUSH 'ANTHONY WATERER' SPIREA	36", HT & WD, CNTNR.	6' O.C.
MEDIUM EVERGREEN HEDGE	42	•	PRUNUS LAUROCERASUS 'OTTO LUYKENS' MYRICA PENSYLVANICA	'OTTO LUYKENS' CHERRY LAUREL COMPACT SPREADING YEW NORTHERN BAYBERRY	24", HT & WD, CNTNR.	4.5' O.C.
FLOWERING EVERGREEN	3	(b)	RHODODENDRON 'ANNA ROSE WHITNEY' RHODODENDRON 'CUNNINGHAM'S WHITE' VIBURNUM 'CHIPPEWAH'	'ANNA ROSE WHITNEY'RHODODENDRON 'CUNNINGHAM'S WHITE' RHODODENDRON 'CHIPPEWAH' VIBURNUM	36", HT & WD, CNTNR.	5.5' 0.C.
BLUE/PURPLE FLOWERING PERRENIALS	12	8	*LAVENDULA ANGUSTIFOLIA 'BUENA VISTA' SALVIA NEMEROSA 'AY NIGHT' LINUM PERENNE 'APPAR'	'BUENA VISTA' LAVENDER 'MAY NIGHT' SALIVA 'APPAR' BLUE FLAX	4" FULL POTS	1.5' O.C.
DWARF RED EVERGREEN SHRUBS	47	⊗	NANDINA DOMESTICA 'FIREPOWER' BERBERIS THUNBERGII "ROSY GLOW'	FIREPOWER NANDINA FIREPOWER NANDINA	18", HT &	2' O.C.
TALL FLOWERING PERRENIALS	4		HELIANTHUS MAXIMILIANA 'SANTA FE' ALCEA ROSEA 'CHATTERS DOUBLE GROUP PINK'	MAXIMILIAN'S SUNFLOWER CHATTERS DOUBLE HOLLYHOCKS	4" FULL POTS	3' O.C.
LOW EVERGREEN HEDGE	10	*	TAXUS BACCATA REPANDENS BUXUS X GREEN GEM	SPREADING ENGLISH YEW GREEN GEM BOXWOOD	18", HT & WD, CNTNR.	3' O.C.

*2" LAYER OF PEA GRAVEL INSTEAD OF SHREDDED MULCH

SEE HDROMULCH SPECIFICATION ON THE LANDSCAPE DETAILS & SPECIFICATIONS SHEET FOR LAWN AREA.

Dewberry

Dewberry & Davis, LLC 401 S. FAIRFAX BOULEVARD, SUITE 3 RANSON, WV 25438-1611 PHONE: 304.725.4572 FAX: 304.725.6896 WWW.DEWBERRY.COM

Owned By: MSA, Inc.

SCALE: 1"=20' GRAPHIC SCALE

(IN FEET) 1 inch = 20 ft.

7	04-23-09	LDM	PER COMMENTS
6	03-27-09	AFJ	PARKING ADDITIONS
NO.	DATE	BY	DESCRIPTION
DEV	TCIONC		

REVISIONS

DRAWN BY

Landscaping & Lighting Sheet

PROJECT NO. 50019902

SITE PLAN REFERENCE STPL 2009-0003

SHEET 9 OF 10

LANDSCAPE SPECIFICATIONS

- 1. ALL PLANT MATERIAL SHALL CONFORM TO CURRENT AMERICAN ASSOCIATION OF NURSERYMEN'S STANDARDS AND TO "HORTUS THIRD" (1977 EDITION) FOR BOTANICAL AND COMMON NAMES.
- 2. BALLED AND BURLAPPED PLANTS SHALL BE DUG WITH FIRM NATURAL BALLS OF EARTH. BALL SIZES SHALL BE IN ACCORDANCE WITH A.A.N. SPECIFICATIONS. ALL CONTAINER GROWN STOCK SHALL BE WELL ROOTED AND ESTABLISHED IN THE CONTAINER IN WHICH IT IS SOLD. AN ESTABLISHED CONTAINER GROWN PLANT SHALL HAVE A ROOT SYSTEM DEVELOPED SUFFICIENTLY TO RETAIN ITS SHAPE WHEN REMOVED.
- 3. ALL PLANT MATERIAL SHALL BE NURSERY GROWN UNLESS OTHERWISE SPECIFIED. PRUNING SHALL BE DONE BEFORE PLANTING OR DURING THE PLANTING OPERATION.
- 4. A COMPLETE LIST OF PLANTS, INCLUDING A SCHEDULE OF SIZES, QUANTITIES, AND OTHER REQUIREMENTS IS SHOWN ON THE DRAWINGS.
 IN THE EVENT THAT QUANTITY DISCREPANCIES OR MATERIAL OMISSIONS OCCUR IN THE PLANT MATERIALS LIST, THE PLANTING PLANS SHALL GOVERN.
- 5. LOCATE PLANTS AS INDICATED OR AS APPROVED IN THE FIELD AFTER STAKING BY THE CONTRACTOR. IF OBSTRUCTIONS ARE ENCOUNTERED THAT ARE NOT SHOWN ON THE DRAWINGS, DO NOT PROCEED WITH PLANTING OPERATIONS UNTIL ALTERNATE PLANT LOCATIONS HAVE BEEN SELECTED.
- 6. ALL PLANT MATERIAL SHALL BE COVERED AND PROTECTED FROM EXCESSIVE DRYING DURING TRANSIT AND DURING ON SITE STORAGE.
- 7. ANTI-DESICCANTS SHALL BE APPLIED ON ALL MATERIAL DUG WHILE IN FOLIAGE.
- 8. PROTECT EXISTING UTILITIES, PAVING AND OTHER FACILITIES FROM DAMAGE CAUSED BY LANDSCAPING OPERATIONS.
- 9. MULCH MATERIAL SHALL BE SHREDDED HARDWOOD BLACK MULCH.
 MATERIAL SHALL BE MULCHING GRADE,
 UNIFORM IN SIZE AND FREE OF FOREIGN MATTER.
- 10. TOPSOIL MIXTURE SHALL BE TWO PARTS EXISTING TOPSOIL MIXED EVENLY WITH ONE PART SPHAGNUM PEAT MOSS OR PEAT HUMUS. EXISTING TOPSOIL SHALL BE FREE OF STONES, LUMPS, PLANTS, ROOTS AND OTHER DEBRIS OVER 4cm. IT SHALL NOT CONTAIN TOXIC SUBSTANCES HARMFUL TO PLANT GROWTH. TOPSOIL SHALL HAVE A PH RANGE OF 5.0 TO 7.0.
- 11. PLANTING PROCEDURES FOR TREES AND SHRUBS:
 - A. PLANTING SHALL OCCUR IN ACCORDANCE WITH ALL
 - B. TREES AND SHRUBS SHALL BE PLACED IN THE PLANTING PIT, BY LIFTING FROM THE BALL (NEVER FROM THE BRANCHES OR TRUNK). ALL PLANT MATERIAL SHALL BE PLACED IN A STRAIGHT POSITION WITHIN THE PLANTING PIT WITH THE MOST DESIRABLE SIDE PLACED TOWARDS THE PROMINENT VIEW (SIDEWALK, STREET, ETC.).
 - C. THE TREE OR SHRUB PIT SHALL BE BACKFILLED WITH A SOIL MIXTURE, AS PER #7 OF THESE SPECIFICATIONS. THE PIT SHALL BE FILLED HALFWAY INITIALLY AND TAMPED FIRMLY. ALL ROPES, WIRES, ETC. ON THE ROOTBALL SHALL BE CUT AND THE BURLAP OR BALL WRAP PULLED BACK TO THE EDGE OF THE ROOTBALL. COMPLETE BACKFILLING THE PLANT PIT AND TAMP FIRMLY. BACKFILL SOILS SHALL NOT COVER THE TOP OF THE ROOTBALL. MULCH THE ROOTBALL AND SAUCER WITH A MINIMUM OF 8cm SHREDDED HARDWOOD OR PINE BARK MULCH. WATER THOROUGHLY OR UNTIL PLANT PIT IS FILLED WITHIN ONE HOUR OF PLANTING.
- 12. PERFORM CLEANING DURING INSTALLATION OF THE WORK AND UPON COMPLETION OF THE WORK, REMOVE FROM SITE ALL EXCESS MATERIALS, SOIL, DEBRIS, AND EQUIPMENT. REPAIR DAMAGE RESULTING FROM PLANTING OPERATIONS.
- 13. FINAL ACCEPTANCE AND WARRANTY PER AGREEMENT BETWEEN OWNER AND CONTRACTOR.

SEEDING SPECIFICATIONS

- I. SEEDING
- ALL SEEDING SHALL BE PERFORMED PER SEEDING CHART. NO SEEDING SHALL BE DONE ON FROZEN GROUND OR WHEN TEMPERATURE IS 32ø FAHRENHEIT OR LOWER.
- II. MULCHING

 FOLLOWING SEEDING, APPLY A ONE INCH LAYER OF STRAW TO HASTEN
 GERMINATION. STRAW MULCH SHALL BE ANCHORED BY EITHER A MULCH
 TILLER. ASPHALT EMULSION, CHEMICAL MULCH BINDER, TWINE OR
 NETTING.
- III, FINAL ACCEPTANCE

FINAL ACCEPTANCE AND WARRANTY PER AGREEMENT BETWEEN OWNER AND

SOIL PREPARATION FOR SEEDING OR SODDING

- EXISTING SOIL OR TOP SOIL STORED ON SITE AND SPREAD AT A 20 24"
 DEPTH OVER AREAS TO BE SEEDED SHALL BE USED FOR ESTABLISHMENT
 OF TURF. ALL SUBGRADE AREAS TO BE SEEDED SHALL BE LOOSENED
 BY DISCING OR BY SCARIFYING TO A DEPTH OF NO LESS THAN 4".
 ALL ESTABLISHED/EXISTING SITE GRADES MUST BE
 MAINTAINED. ANY ALTERATION OF EXISTING GRADES COULD CAUSE
 DRAINAGE PROBLEMS. THE AREA TO BE SEEDED SHALL BE FREE FROM
 ROOTS, BRUSH, STONES AND TRASH LARGER THAN 1.5" DIAMETER
 OR LENGTH.
- 2. SOIL TESTS SHALL BE CONDUCTED TO DETERMINE EXACT REQUIREMENTS FOR BOTH LIME AND FERTILIZER. SOIL TESTS SHALL BE CONDUCTED BY A STATE LABORATORY OR RECOGNIZED COMMERCIAL LABORATORY.
 - A. FERTILIZER: ALL FERTILIZER SHALL BE UNIFORM IN COMPOSITION FREE FLOWING AND SUITABLE FOR APPLICATION WITH APPROVED EQUIPMENT. FERTILIZER APPLICATION RATES SHALL BE DETERMINED BY SOIL TESTS. FERTILIZER SHALL BE DISTRIBUTED EVENLY OVER THE ENTIRE AREA TO BE SEEDED.
 - B. LIME: LIME MATERIAL SHALL BE GROUND LIMESTONE (HYDRATED OR BURNT LIME MAY BE SUBSTITUTED) WHICH CONTAINS AT LEAST 50% TOTAL OXIDES (CALCIUM OXIDE PLUS MAGNESIUM OXIDE) APPLICATION RATES FOR LIMING MATERIALS SHALL BE DETERMINED BY SOIL TESTS. LIME SHALL BE DISTRIBUTED UNIFORMLY OVER THE ENTIRE AREA TO BE SEEDED.
- 3. ALL LIME AND FERTILIZER SHALL BE UNIFORMLY MIXED INTO THE TOP 4" OF SOIL BY DISCING, HARROWING OR OTHER APPROVED METHODS. ANY UNDULATIONS OR IRREGULARITIES IN THE SURFACE RESULTING FROM FERTILIZING, TILLING OR OTHER CAUSES SHALL BE LEVELED PRIOR TO SEEDING.

HYDROMULCH SEEDING SPECIFICATIONS

I. SEEDING


NO SEEDING SHALL BE DONE ON FROZEN GROUND OR WHEN TEMPERATURE IS 32 DEGREES FAHRENHEIT OR LOWER.


II. HYDROMULCHING

A THICK COAT OF MULCH/SEED/FERTILIZER/WATER MIX SHALL BE APPLIED TO ALL BARE GROUND AREAS ONSITE NOT DESIGNATED AS SHRUB/PERENNIAL BED AREAS. A MINIMUM OF ONE INCH THICK OF COVER SHALL BE APPLIED. WHERE LAWN AREAS MEET PLANTING BEDS, THE PLANTING BEDS SHALL BE COVERED ALONG THE EDGE SO THAT A SHARP DEFINED EDGE OF HYDROMULCH IS ACHIEVED AND NO SEED MIX IS DEPOSITED IN THE BEDS.

III. FINAL ACCEPTANCE


FINAL ACCEPTANCE AND WARRANTY PER AGREEMENT BETWEEN OWNER AND CONTRACTOR.

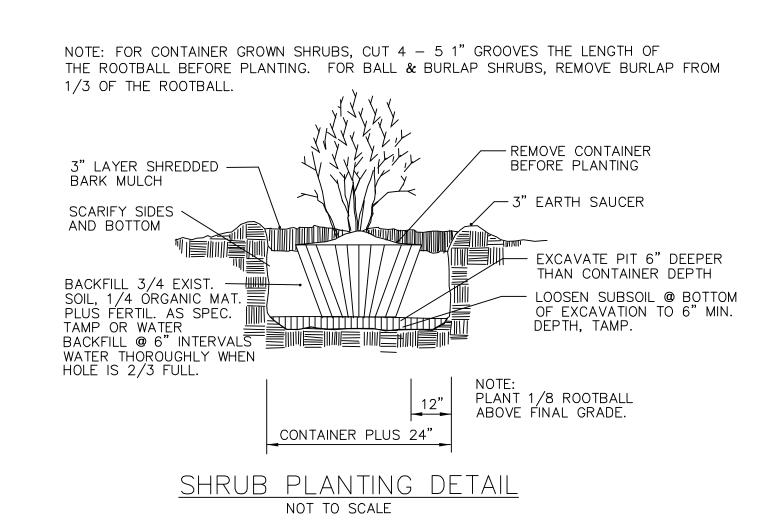

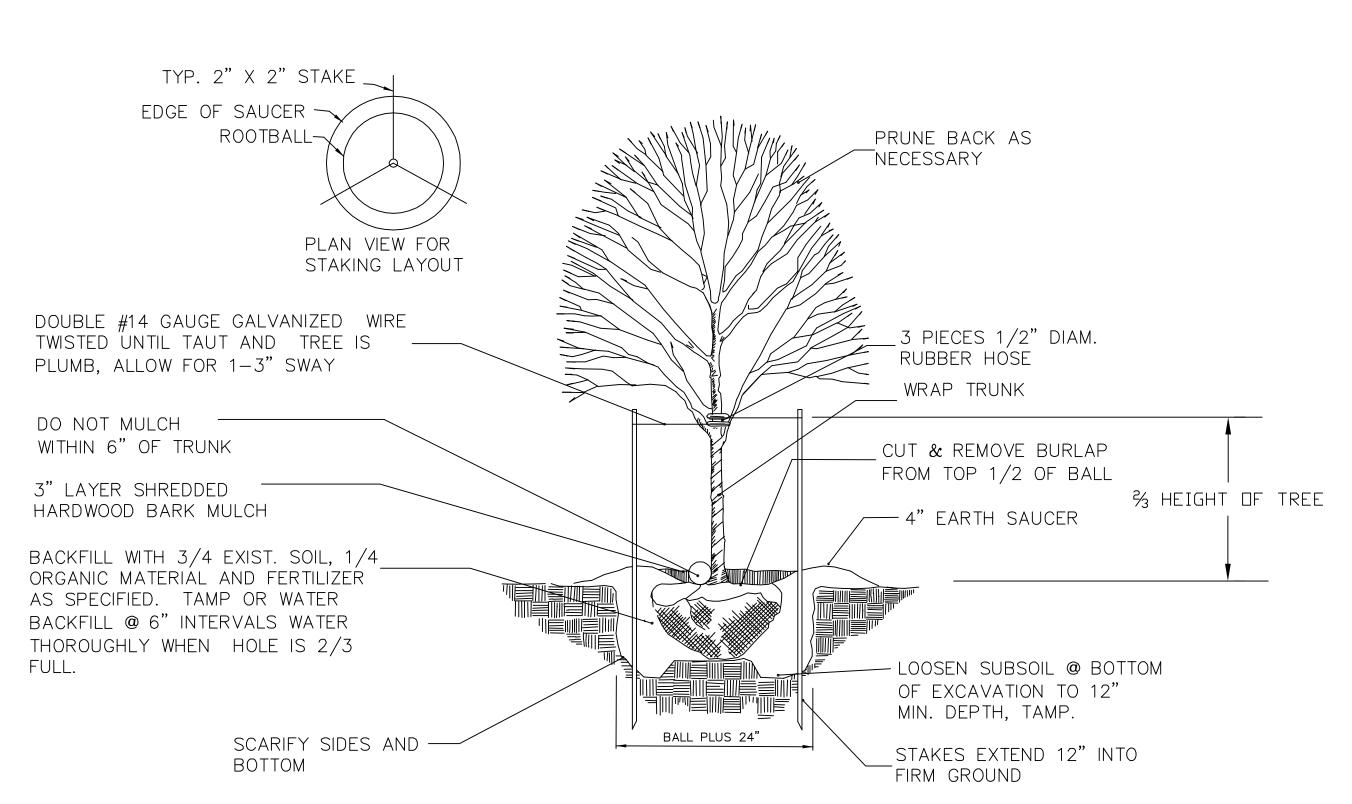


NOTE: PLANT 1/8 OF ROOTBALL ABOVE FINAL GRADE IN CLAY SOILS.

UNDER 3" CALIPER DECIDUOUS TREE PLANTING DETAIL
NTS

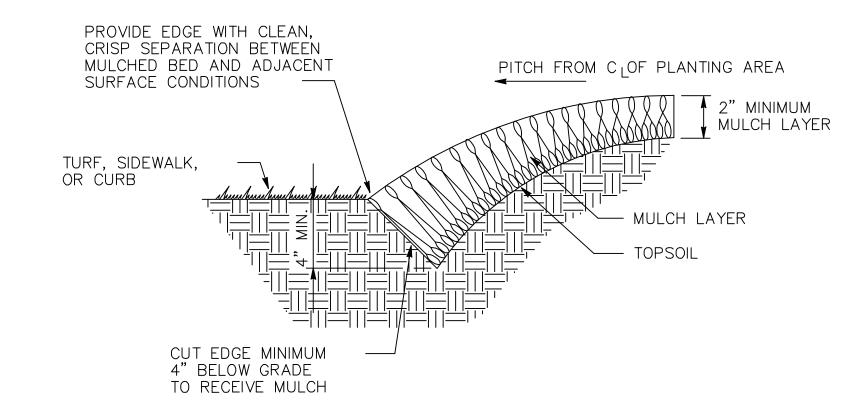

TYPICAL MULCH EDGING DETAIL

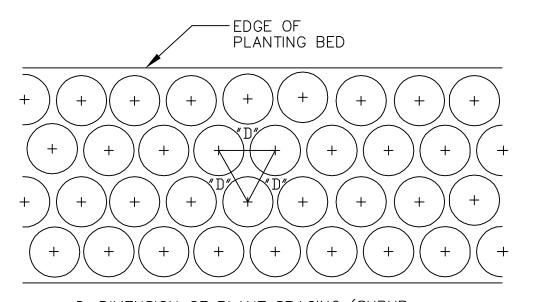

D=DIMENSION OF PLANT SPACING (SHRUB, GROUNDCOVER, ORNAMENTAL GRASS OR PERENNIAL) AS INDICATED ON PLANS OR PLANT SCHEDULE.

PLANT SPACING DIAGRAM



Dewberry & Davis, LLC
401 S. FAIRFAX BOULEVARD, SUITE 3
RANSON, WV 25438-1611
PHONE: 304.725.4572
FAX: 304.725.6896
WWW.DEWBERRY.COM

Owned By: MSA, Inc.

THE GATEWAY

THE GATEWAY

BUILDING, LLC

CITY OF CHARLES TOWN

FFERSON COUNTY, WEST VIRGIN

SCALE: 1"=20'

GRAPHIC SCALE

0 10 20 40

(IN FEET)
1 inch = 20 ft.

H

7 04-23-09 LDM Per comments
6 03-27-09 AFJ Parking additions
NO. DATE BY DESCRIPTION
REVISIONS

DRAWN BY AFJ

APPROVED BY LDM

CHECKED BY AFJ


DATE March 2009

Landscaping Details

PROJECT NO. 50019902

SITE PLAN REFERENCE
STPL 2009-0003

SHEET 10 OF 10

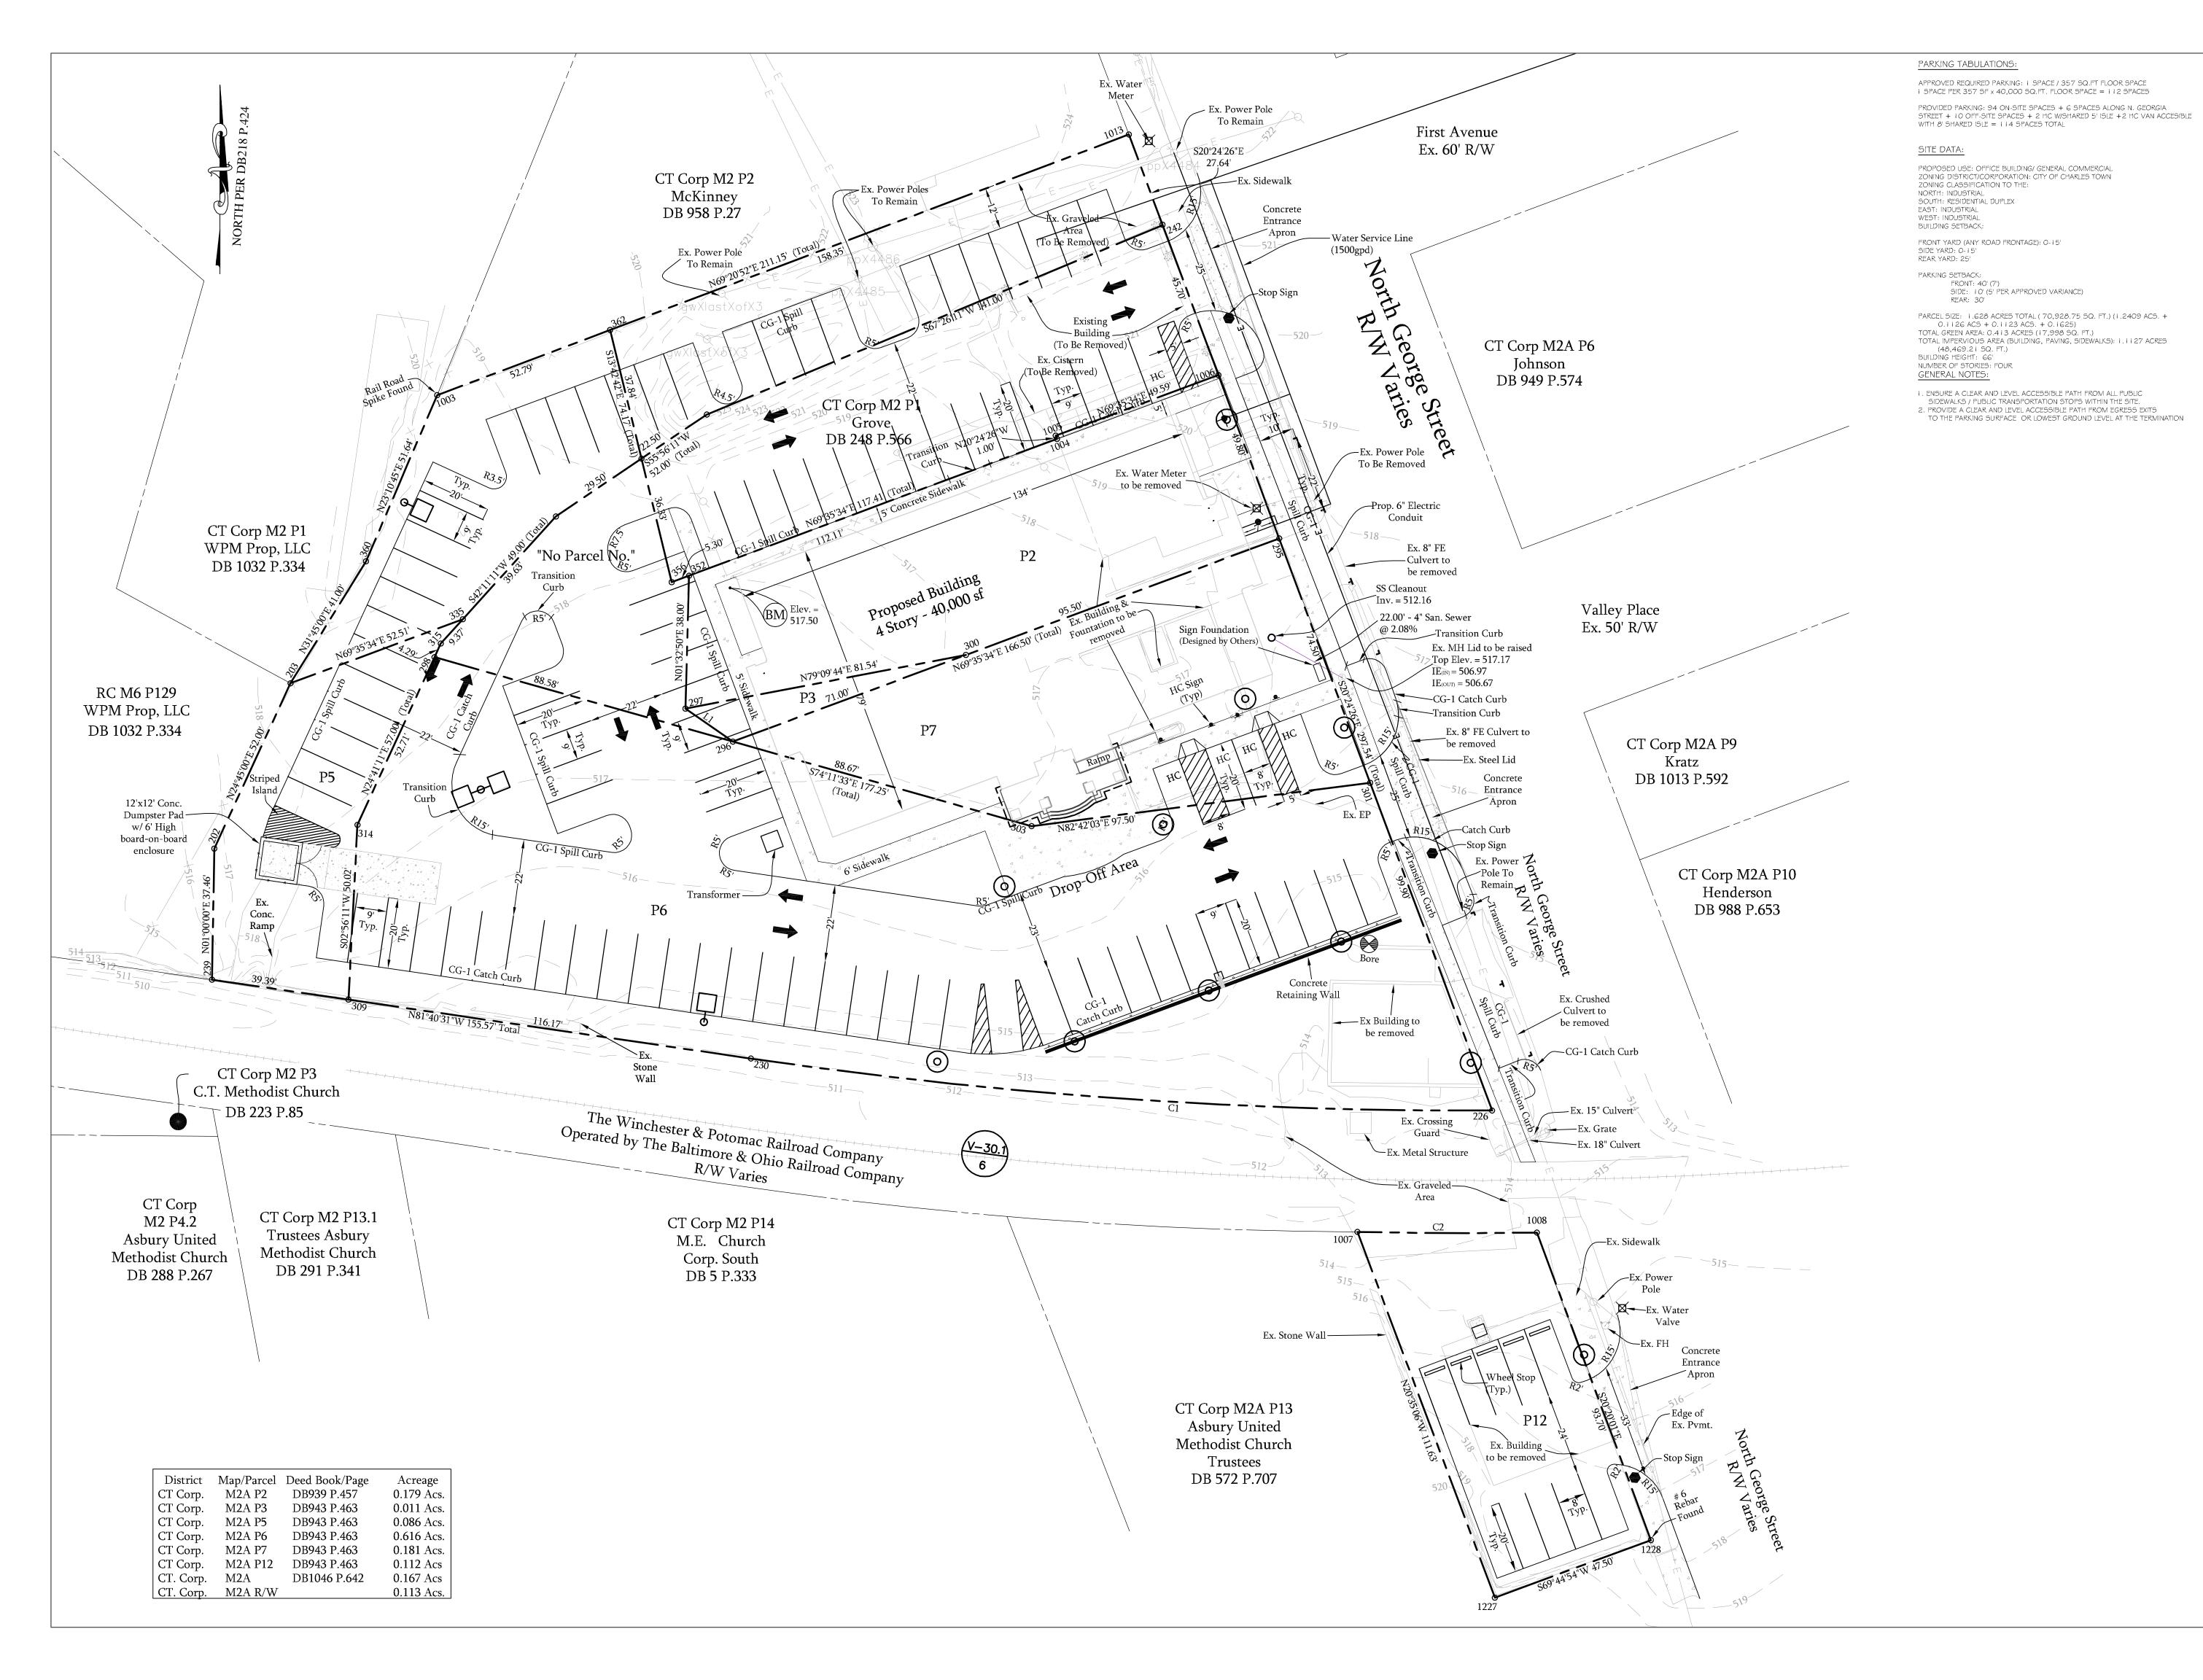



Dewberry & Davis, LLC 401 S. FAIRFAX BOULEVARD, SUITE 3 RANSON, WV 25438-1611 PHONE: 304.725.4572 FAX: 304.725.6896 WWW.DEWBERRY.COM

> Owned By: MSA, Inc.

SHOWING SITE

SCALE: 1"=20'

(IN FEET) 1 inch = 20 ft.

5 03-27-08 CRG Deed Reference per City CT commer 4 01-15-08 CRG PER COMMENTS WVDEP (T. CARR) 2 09-17-07 CBB PER COMMENTS BY CITY OF CT 1 08-27-07 CRG REVISED 22 ISLE WIDTH AND 5 BRL NO. DATE BY DESCRIPTION

REVISIONS

DATE

DRAWN BY APPROVED BY LDM CHECKED BY

Overall

APRIL 2007

PROJECT NO. 50002333

SITE PLAN REFERENCE

STPL 2007 0009

SHEET 2 OF 10